

**STATE OF CONNECTICUT**

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GOVERNOR

DEPARTMENT OF PUBLIC WORKS  
JONATHON P. HOLMES  
ACTING COMMISSIONER

PROJECT:

**BOILER & HOT WATER  
HEATER UPGRADES**

NORWALK & ENFIELD ARMORIES  
NORWALK & ENFIELD, CONNECTICUT

PROJECT NO: BI-Q-644

AGENCY TRACKING NO: ZZ1101

**MILITARY DEPARTMENT**



MAJOR GENERAL THADDEUS J. MARTIN  
ADJUTANT GENERAL

**STATE OF CONNECTICUT  
MILITARY DEPARTMENT  
FACILITIES MANAGEMENT OFFICE**

360 BROAD STREET  
HARTFORD, CONNECTICUT 06105

**LIST OF DRAWINGS**

- C-1 COVER SHEET
- MEP-1.0 MEP GENERAL NOTES AND ABBREVIATIONS
- MEP-1.1 MEP SYMBOL LISTS
- MEP-2.0 MEP DETAILS
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- SU-1.0 NORWALK ARMORY SITE PLAN
- P-1.0 ENFIELD ARMORY PLUMBING BOILER ROOM PART PLANS
- P-2.0 NORWALK ARMORY PLUMBING BOILER ROOM PART PLANS
- H-1.0 ENFIELD ARMORY HVAC BOILER ROOM PART PLANS
- H-2.0 DETAILS

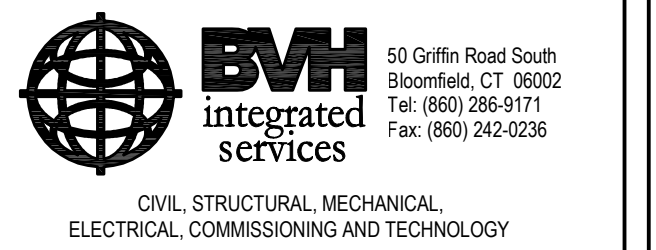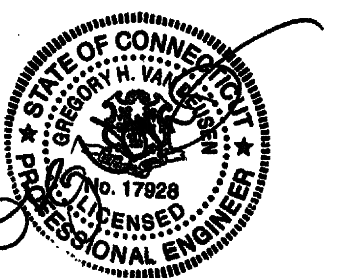

REVISION		
Mark	Date	Description


Drawn by: **MGK**  
 App'd by: **ARA**  
 Scale: **AS NOTED**  
 File as:  

STATE OF CONNECTICUT  
 MILITARY DEPARTMENT  
 Facilities Management Office  
 360 Broad Street Hartford, CT 06105  
 860-493-2722 Fax 860-534-4937

Project  
**BOILER AND HOT WATER  
 HEATER UPGRADES**  
 CT. ARMY NATIONAL GUARD ENFIELD/NORWALK, CT

Drawing Title  
**COVERSHEET**

Date  
**28 FEBRUARY 2011**  
 Drawing No  
**C-1**  
 Tracking No.  
**ZZ1101**

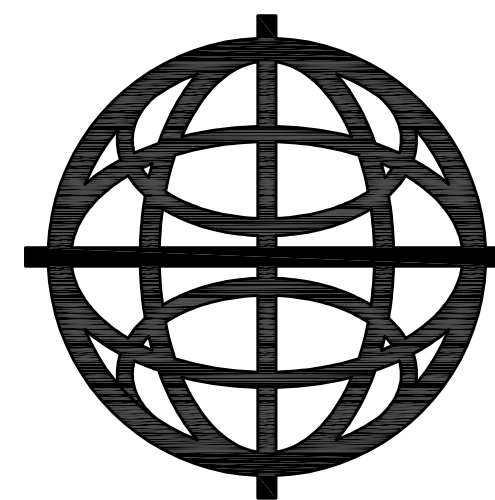

**BVH**  
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CIVIL, STRUCTURAL, MECHANICAL,  
ELECTRICAL, COMMISSIONING AND TECHNOLOGY


**BVH PROJECT #21-10-155**

**ISSUED FOR CONSTRUCTION  
02-28-2011**

**ENFIELD ARMORY**



**NORWALK ARMORY**

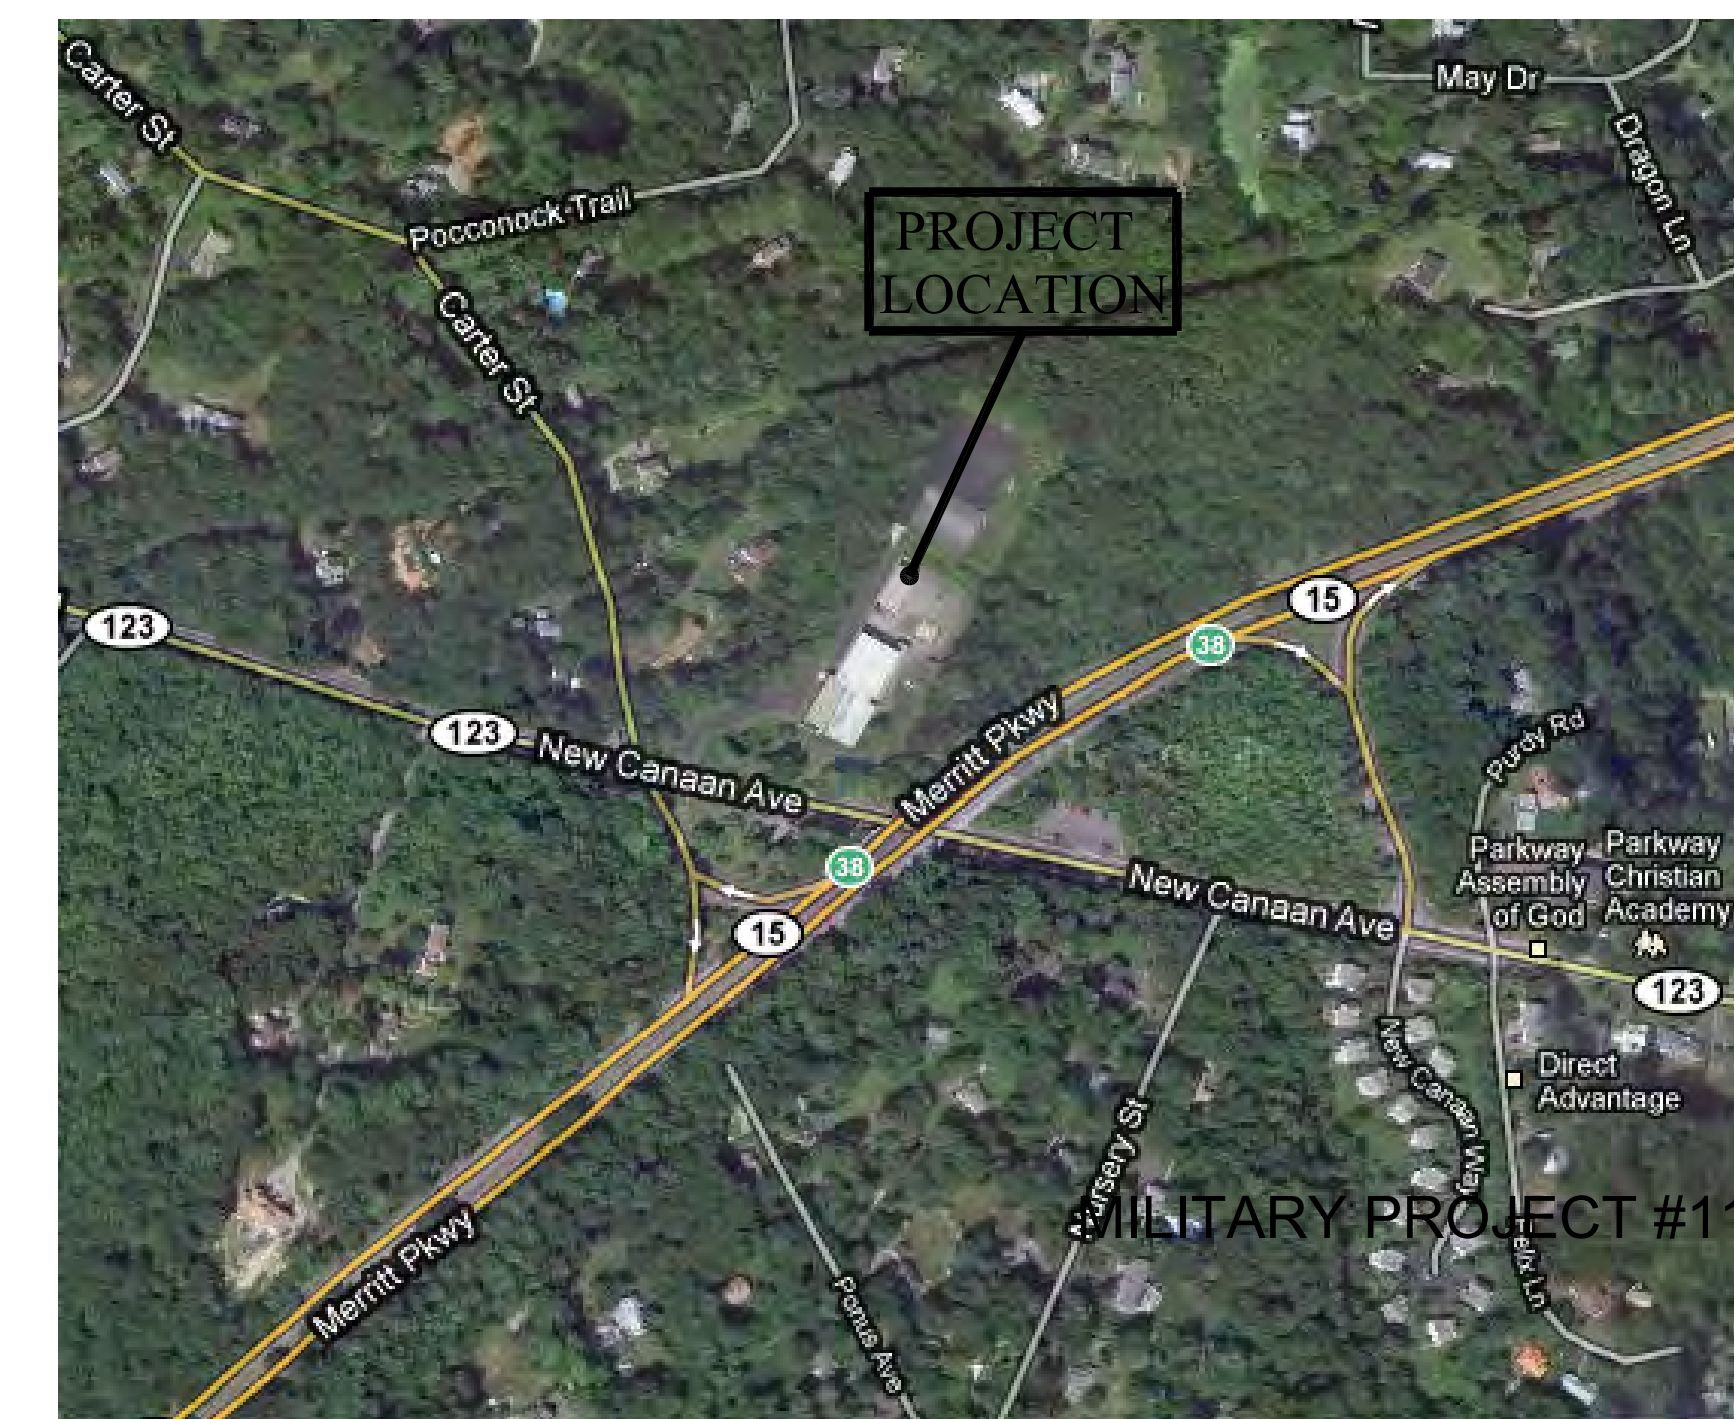

MILITARY PROJECT #11MIL217-2401



ABBREVIATIONS

Table of abbreviations and their corresponding full names, organized in four columns. Includes terms like AC, AD, AF, AG, AI, etc.

GENERAL NOTES

GENERAL

- 1. THE PROJECT DRAWINGS AND SPECIFICATIONS ARE BASED ON THE CONSTRUCTION SPECIFICATIONS INSTITUTE (CSI) DOCUMENTATION FORMAT... 2. THE INTENT OF THESE DOCUMENTS IS FOR THE MEP TRADES TO FURNISH AND INSTALL COMPLETE MECHANICAL AND ELECTRICAL SYSTEMS...

PLUMBING

- 1. INCLUDE NECESSARY PIPING OFFSETS AND TRANSITIONS AS REQUIRED TO INSTALL THE PLUMBING EQUIPMENT... 2. COORDINATE EXACT LOCATION OF UNDERGROUND UTILITIES (WATER, GAS, SANITARY, ETC.) EXISTING OR ENTERING THE BUILDING...

HVAC

- 1. PROVIDE THROTTLING VALVES AND SHUT-OFF VALVES AS SPECIFIED IN ADDITION TO THOSE INDICATED ON THE DOCUMENTS... 2. PIPING SHALL BE SUPPORTED FROM STRUCTURE ABOVE... 3. PROVIDE AIR VENTS AT ALL HIGH POINTS AND DRAINS AT ALL LOW POINTS.

ELECTRICAL

- 1. IT IS NOT THE INTENTION TO SHOW EVERY FITTING, WIRE, OR DEVICE... 2. CONCEAL RACEWAYS IN FINISHED AREAS... 3. DO NOT INSTALL CONDUIT IN CONCRETE SLABS... 4. PROVIDE POWER TO MECHANICAL EQUIPMENT SHOWN ON MECHANICAL PLANS...

RENOVATION

- 1. THIS PROJECT INVOLVES THE RENOVATION OF AN EXISTING FACILITY... 2. CONTRACTORS SHALL BE HELD RESPONSIBLE FOR ASSUMPTIONS, OMISSIONS OR ERRORS MADE... 3. IT IS NOT THE INTENT OF THESE DOCUMENTS TO SHOW EVERY DEVICE, APPURTENANCE, PIPE, WIRE OR CONDUIT TO BE REMOVED...

ROOF

- 1. THE CONTRACTOR IS RESPONSIBLE TO COORDINATE ALL ROOF WORK WITH BOTH: THE ROOF WARRANTY HOLDER AND THE MILITARY DEPARTMENT'S CONSTRUCTION COORDINATOR...

CODES LISTED BELOW APPLY TO ALL DRAWINGS AND SPECIFICATIONS ON THIS PROJECT

- 2003 INTERNATIONAL BUILDING CODE
• 2005 SUPPLEMENT TO THE 2003 INTERNATIONAL BUILDING CODE
• 2009 AMENDMENT TO THE 2005 SUPPLEMENT TO THE 2003 INTERNATIONAL BUILDING CODE
• 2005 CONNECTICUT STATE FIRE SAFETY CODE
• 2009 AMENDMENT TO THE 2005 CONNECTICUT STATE FIRE SAFETY CODE
• 2003 INTERNATIONAL MECHANICAL CODE (IMC)
• 2003 INTERNATIONAL PLUMBING CODE (IPC)
• 2006 INTERNATIONAL ENERGY CONSERVATION CODE (IECC)
• 2003 ICC/ANSI A117.1 - ACCESSIBLE AND USABLE BUILDINGS AND FACILITIES
• 2005 NFPA 70 - NATIONAL ELECTRICAL CODE (NEC)
• 2004 ANSI/ASHRAE/ESNA STANDARD 90.1 - ENERGY STANDARD FOR BUILDINGS EXCEPT LOW-RISE RESIDENTIAL BUILDINGS
• 1996 NFPA 54 - CONNECTICUT GAS FUEL CODE
• 2003 INTERNATIONAL ELECTRICAL CODE (IECC)
• 2003 INTERNATIONAL FIRE CODE (IFC)
• 2002 NFPA 72 - NATIONAL FIRE ALARM CODE
• 2002 CT PUBLIC HEALTH CODE
• GENERAL STATUTES OF CONNECTICUT WITH SUPPLEMENTS
• 2002 ASCE/SEI 7

MILITARY PROJECT #11MIL217-2401

Project information block including logos for BVH Integrated Services and the State of Connecticut, drawing title 'MEP GENERAL NOTES AND ABBREVIATIONS', project name 'BOILER & HOT WATER HEATER UPGRADES ENFIELD & NORWALK ARMORIES', and drawing number 'MEP-1.0'.

GENERAL SYMBOLS	
	THICK, DARK SOLID LINES INDICATE NEW OR RELOCATED ITEMS OR NEW RACEWAY AND WIRING
	THIN, LIGHT LINES INDICATE EXISTING ITEMS OR RACEWAY TO REMAIN IN PLACE AND BE REUSED
	THICK, DASHED LINES INDICATE EXISTING ITEMS TO BE REMOVED
	POINT OF NEW TO EXISTING CONNECTION, INCLUDING TRANSITIONS

PLUMBING SYMBOLS	
	COLD WATER
	HOT WATER
	HOT WATER RECIRCULATING
	VENT
	RADON VENT
	SOIL OR WASTE ABOVE GRADE
	SOIL OR WASTE BURIED
	WASTE & VENT COMBINATION ABOVE GRADE
	WASTE & VENT COMBINATION BURIED
	GREASE WASTE ABOVE GRADE
	GREASE WASTE BURIED
	INDIRECT WASTE
	OVERFLOW RAIN WATER LEADER
	RAIN WATER LEADER
	STORM BURIED
	CONDENSATE DRAIN
	PUMPED CONDENSATE DRAIN
	ELECTRICAL HEATING CABLE, REFER TO ABBREVIATION LIST FOR DESIGNATION (XXX)
	GAS ABOVE GRADE
	GENERAL SERVICE COMPRESSED AIR
	TEMPERED WATER
	TEMPERED WATER RETURN
	AIR OUTLET
	WATER METER ASSEMBLY
	GAS METER ASSEMBLY
	DRAIN
	ROOF DRAIN
	TRAP PRIMER
	PANEL/CABINET
	T & P RELIEF VALVE
	SHOWER HEAD - LOCATION
	EMERGENCY EYEWASH/DELUGE SHOWER
	EMERGENCY OFF SWITCH

HVAC SYMBOLS	
	DIRECTION OF OUTDOOR AIRFLOW
	DIRECTION OF EXHAUST AIRFLOW
	SUPPLY PIPING, REFER TO ABBREVIATION LIST FOR DESIGNATION (XXX)
	RETURN PIPING, REFER TO ABBREVIATION LIST FOR DESIGNATION (XXX)
	VARIABLE FREQUENCY CONTROLLER
	EMERGENCY OFF SWITCH

FITTINGS AND VALVES	
	PIPE ANCHOR
	BACKFLOW PREVENTOR
	STRAINER OR STRAINER WITH BLOW-DOWN
	VALVE HOSE END, CAP AND CHAIN
	WALL CLEANOUT OR BLIND FLANGE
	"P" TRAP
	PIPE TEE DOWN
	IN-LINE EXPANSION COMPENSATOR
	FLOOR CLEANOUT
	STEEL PENETRATION/PIPE SLEEVE
	PIPE ELBOW UP OR PIPE TEE UP
	PIPE ELBOW DOWN
	COMPANION FLANGE
	PIPE CAP OR CAPPED END OF PIPE
	UNION
	PIPE GUIDES
	PUMP
	WATER HAMMER ARRESTOR
	TAKEOFF FROM TOP OF MAIN PIPE
	TAKEOFF FROM BOTTOM OF MAIN PIPE
	DIRECTION OF FLUID FLOW
	VALVE ON RISER
	VALVE ON DROP
	METERING ORIFICE
	AIR VENT
	FLOW SENSOR
	PIPE DROP WITH VALVE
	2-WAY CONTROL VALVE
	3-WAY CONTROL VALVE
	BALL VALVE
	CALIBRATED BALANCING VALVE
	SHUT-OFF VALVE (SEE SPECIFICATIONS FOR APPLICATION TYPE)
	BUTTERFLY VALVE
	CHECK VALVE
	THERMOSTATIC MIXING VALVE
	GLOBE VALVE
	GATE VALVE
	PRESSURE REDUCING VALVE
	GAS COCK
	TRIPLE DUTY VALVE
	OS&Y VALVE
	DRAIN VALVE WITH HOSE END, CAP & CHAIN OR WALL HYDRANT / HOSE BIBB
	MOTORIZED BUTTERFLY VALVE
	PRESSURE RELIEF SAFETY VALVE
	AQUASTAT
	SOLENOID VALVE
	TEMPERATURE SENSOR WITH SEPARABLE SOCKET IN IMMERSIBLE WELL
	TEMPERATURE GAUGE WITH SEPARABLE SOCKET IN IMMERSIBLE WELL
	THERMOMETER WITH SEPARABLE SOCKET IN IMMERSIBLE WELL
	PRESSURE GAUGE
	FLEXIBLE CONNECTOR


ELECTRICAL SYMBOLS	
	DOUBLE DUPLEX RECEPTACLE REFER TO ABBREVIATION LIST (X)
	POWER WIRING
	SWITCH LEG WIRING
	CONTROL WIRING
	WIRING - REFER TO ABBREVIATION LIST (XXX)
	CIRCUIT BREAKER SIZE
	HOME RUN
	PANEL DESIGNATION
	FEEDER TAG
	SURFACE ELECTRICAL PANEL, 208Y/120 OR 208 VOLT
	FLUSH ELECTRICAL PANEL, 208Y/120 VOLT
	TRANSFORMER
	ENCLOSED SWITCH
	ENCLOSED CONTROLLER
	ELECTRIC MOTOR
	JUNCTION BOX
	TERMINAL BOX
	CONTACTOR IN ENCLOSURE
	SUBLETTERS "EX" INDICATES EXISTING EQUIPMENT TO REMAIN INTACT
	SUBLETTERS "RE" INDICATES EXISTING EQUIPMENT TO BE DISCONNECTED AND REMOVED
	SUBLETTERS "RL" INDICATES EXISTING EQUIPMENT TO BE DISCONNECTED, REMOVED, AND RELOCATED

MILITARY PROJECT #11MIL217-2401

	<b>MEP SYMBOL LISTS</b>		<b>STATE OF CONNECTICUT</b> DEPARTMENT OF PUBLIC WORKS	
	<b>REVISIONS</b>		drawings prepared by BVH INTEGRATED SERVICES 50 GRIFFIN ROAD SOUTH, BLOOMFIELD, CT 06002	
mark    date    description		date 02/28/2011 state NONE		
CAD no.		project no. 81-Q-644		
project		drawn by GSK, MEL, JCK approved by CVD drawing no. <b>MEP-1.1</b>		




3/1/11 3:04:25 PM W:\2010\2110155 - Norwalk And Enfield Armories Boiler And Water Heater Replacement\DWGS\MEP\MEP-2.dwg

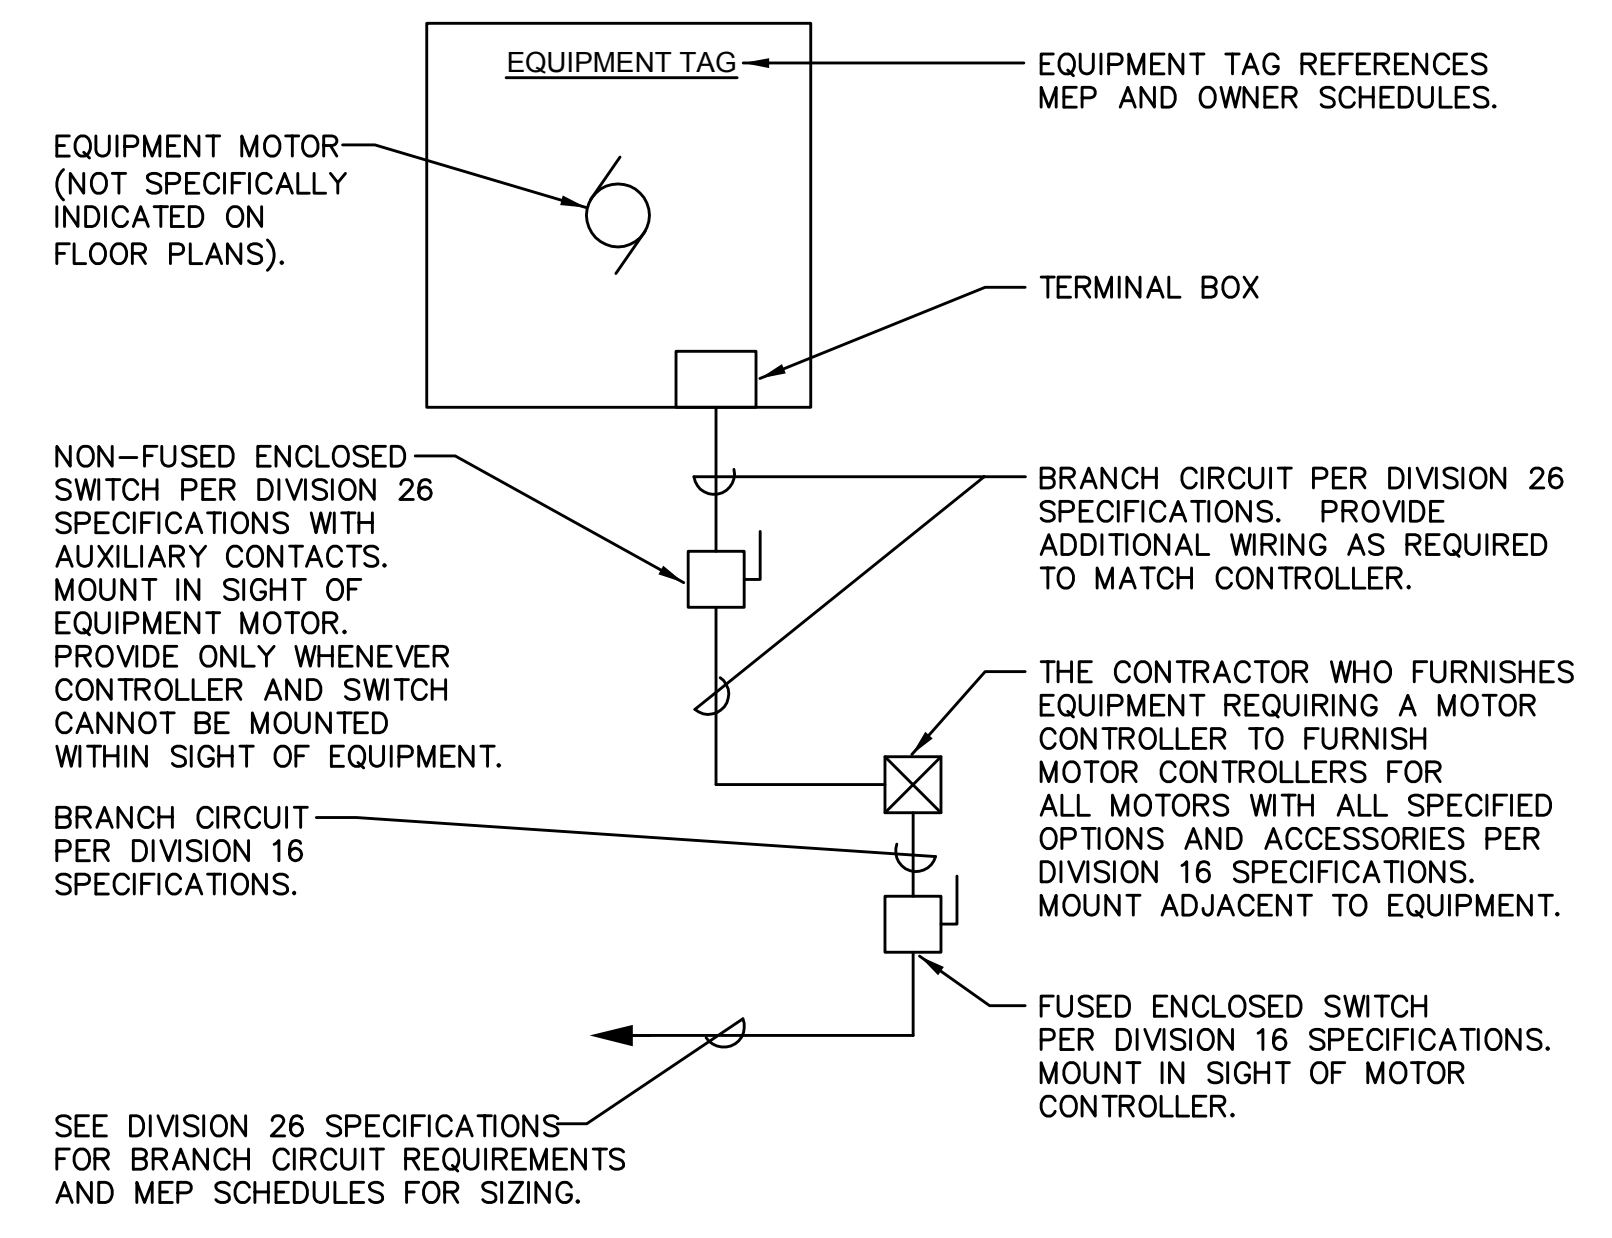


**TYPICAL MOTOR, SWITCH AND CONTROLLER DETAIL - ENFIELD & NORWALK**  
NOT TO SCALE

**NOTE:**  
THIS DETAIL IS FOR ALL EQUIPMENT MOTORS. CONTRACTOR TO PROVIDE WIRING BETWEEN REMOTE DISCONNECTS, STARTERS AND MOTORS. SEE EQUIPMENT SCHEDULES AND SPECIFICATIONS. IF NOT NOTED OTHERWISE IN EQUIPMENT SCHEDULES, CONTRACTOR SHALL PROVIDE A COMBINATION MOTOR CONTROLLER/DISC. SWITCH.

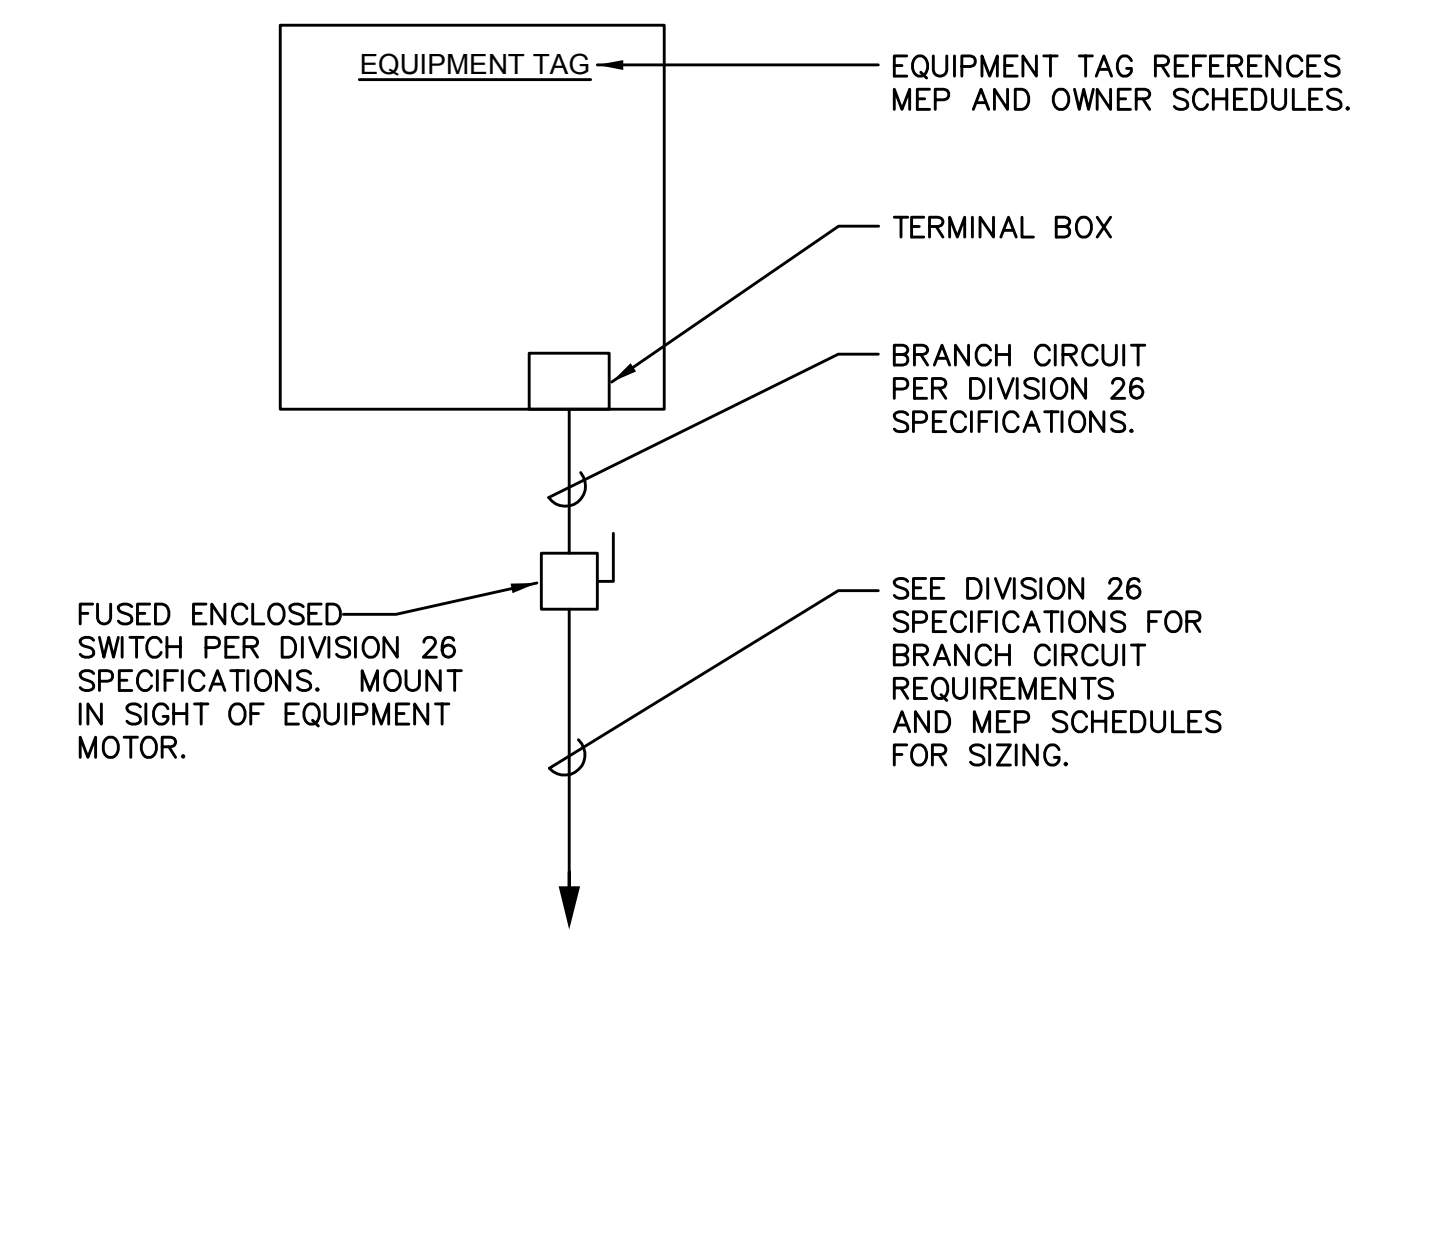


**TYPICAL EQUIPMENT CONNECTION DETAIL - ENFIELD & NORWALK**  
NOT TO SCALE

**NOTE:**  
THIS DETAIL IS FOR ALL EQUIPMENT WHERE EQUIPMENT REQUIRES POWER AND WHERE THERE ARE NO MOTORS INVOLVED OR WHERE SPECIFICATIONS OR SCHEDULES FOR MULTIPLE MOTOR EQUIPMENT SPECIFICALLY INDICATE ONE POINT POWER CONNECTION. CONTRACTOR TO PROVIDE WIRING BETWEEN REMOTE DISCONNECTS, STARTERS AND MOTORS. SEE EQUIPMENT SCHEDULES AND SPECIFICATIONS.

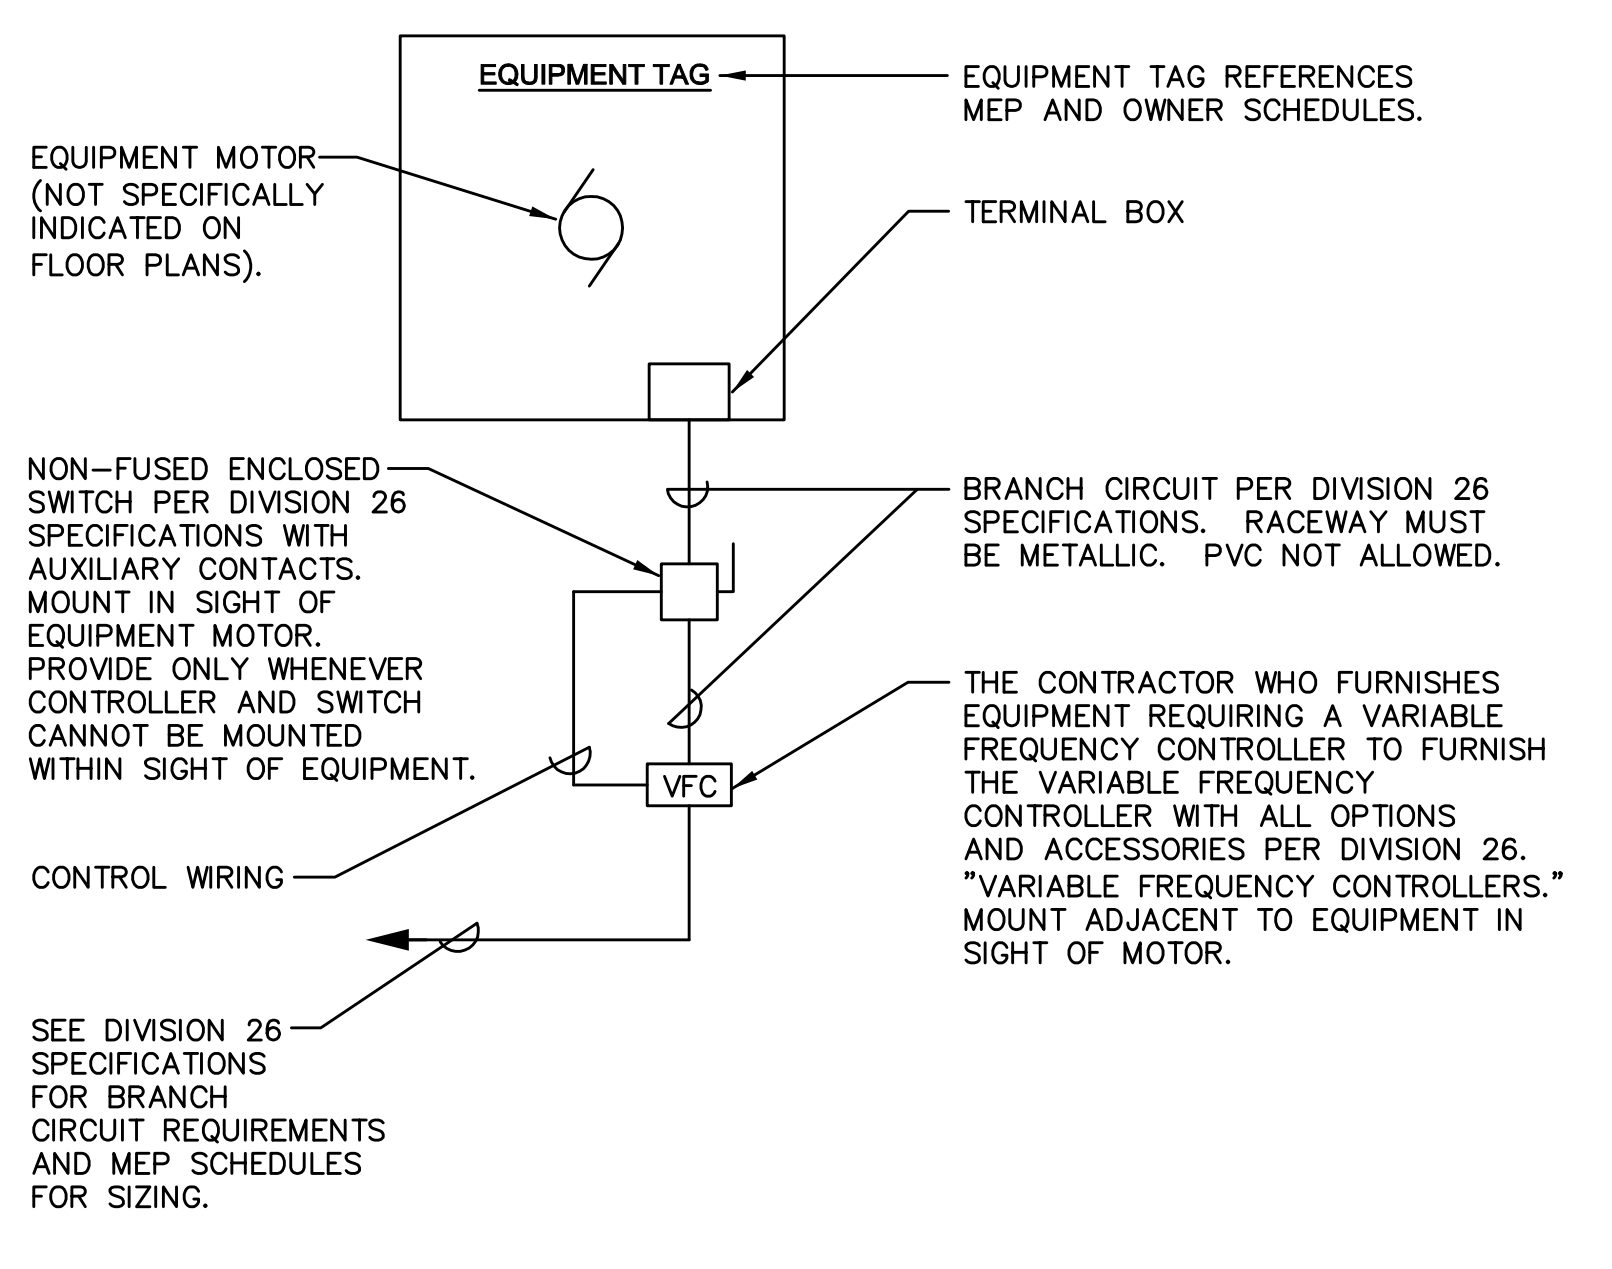


**TYPICAL MOTOR CONTROLLER AND VFC DETAIL - ENFIELD**  
NOT TO SCALE

**NOTE:**  
THIS DETAIL IS FOR ALL EQUIPMENT SPECIFIED WITH VARIABLE FREQUENCY CONTROLLERS, CONTRACTOR TO PROVIDE WIRING BETWEEN REMOTE DISCONNECTS, STARTERS AND MOTORS. SEE EQUIPMENT SCHEDULES AND SPECIFICATIONS.

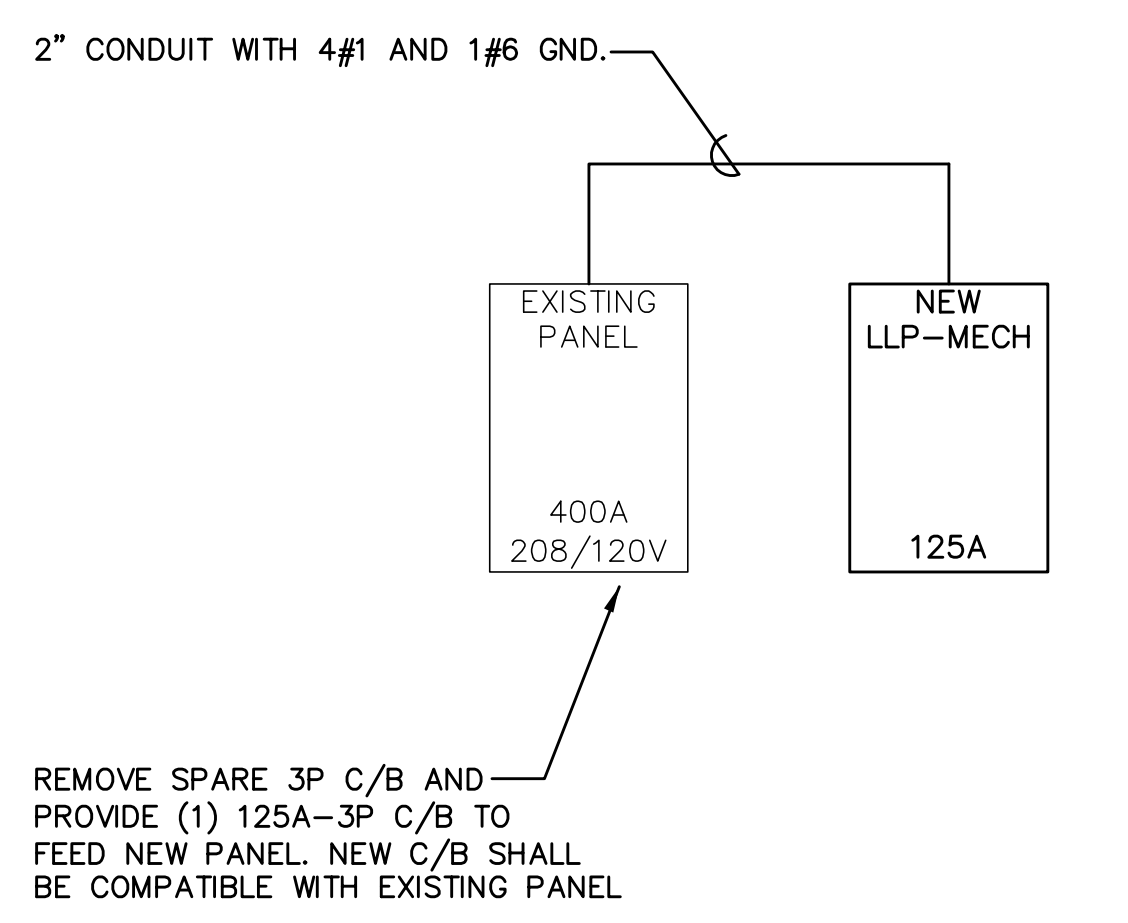


**PARTIAL POWER RISER DETAIL - ENFIELD**  
NOT TO SCALE

REMOVE SPARE 3P C/B AND PROVIDE (1) 125A-3P C/B TO FEED NEW PANEL. NEW C/B SHALL BE COMPATIBLE WITH EXISTING PANEL.

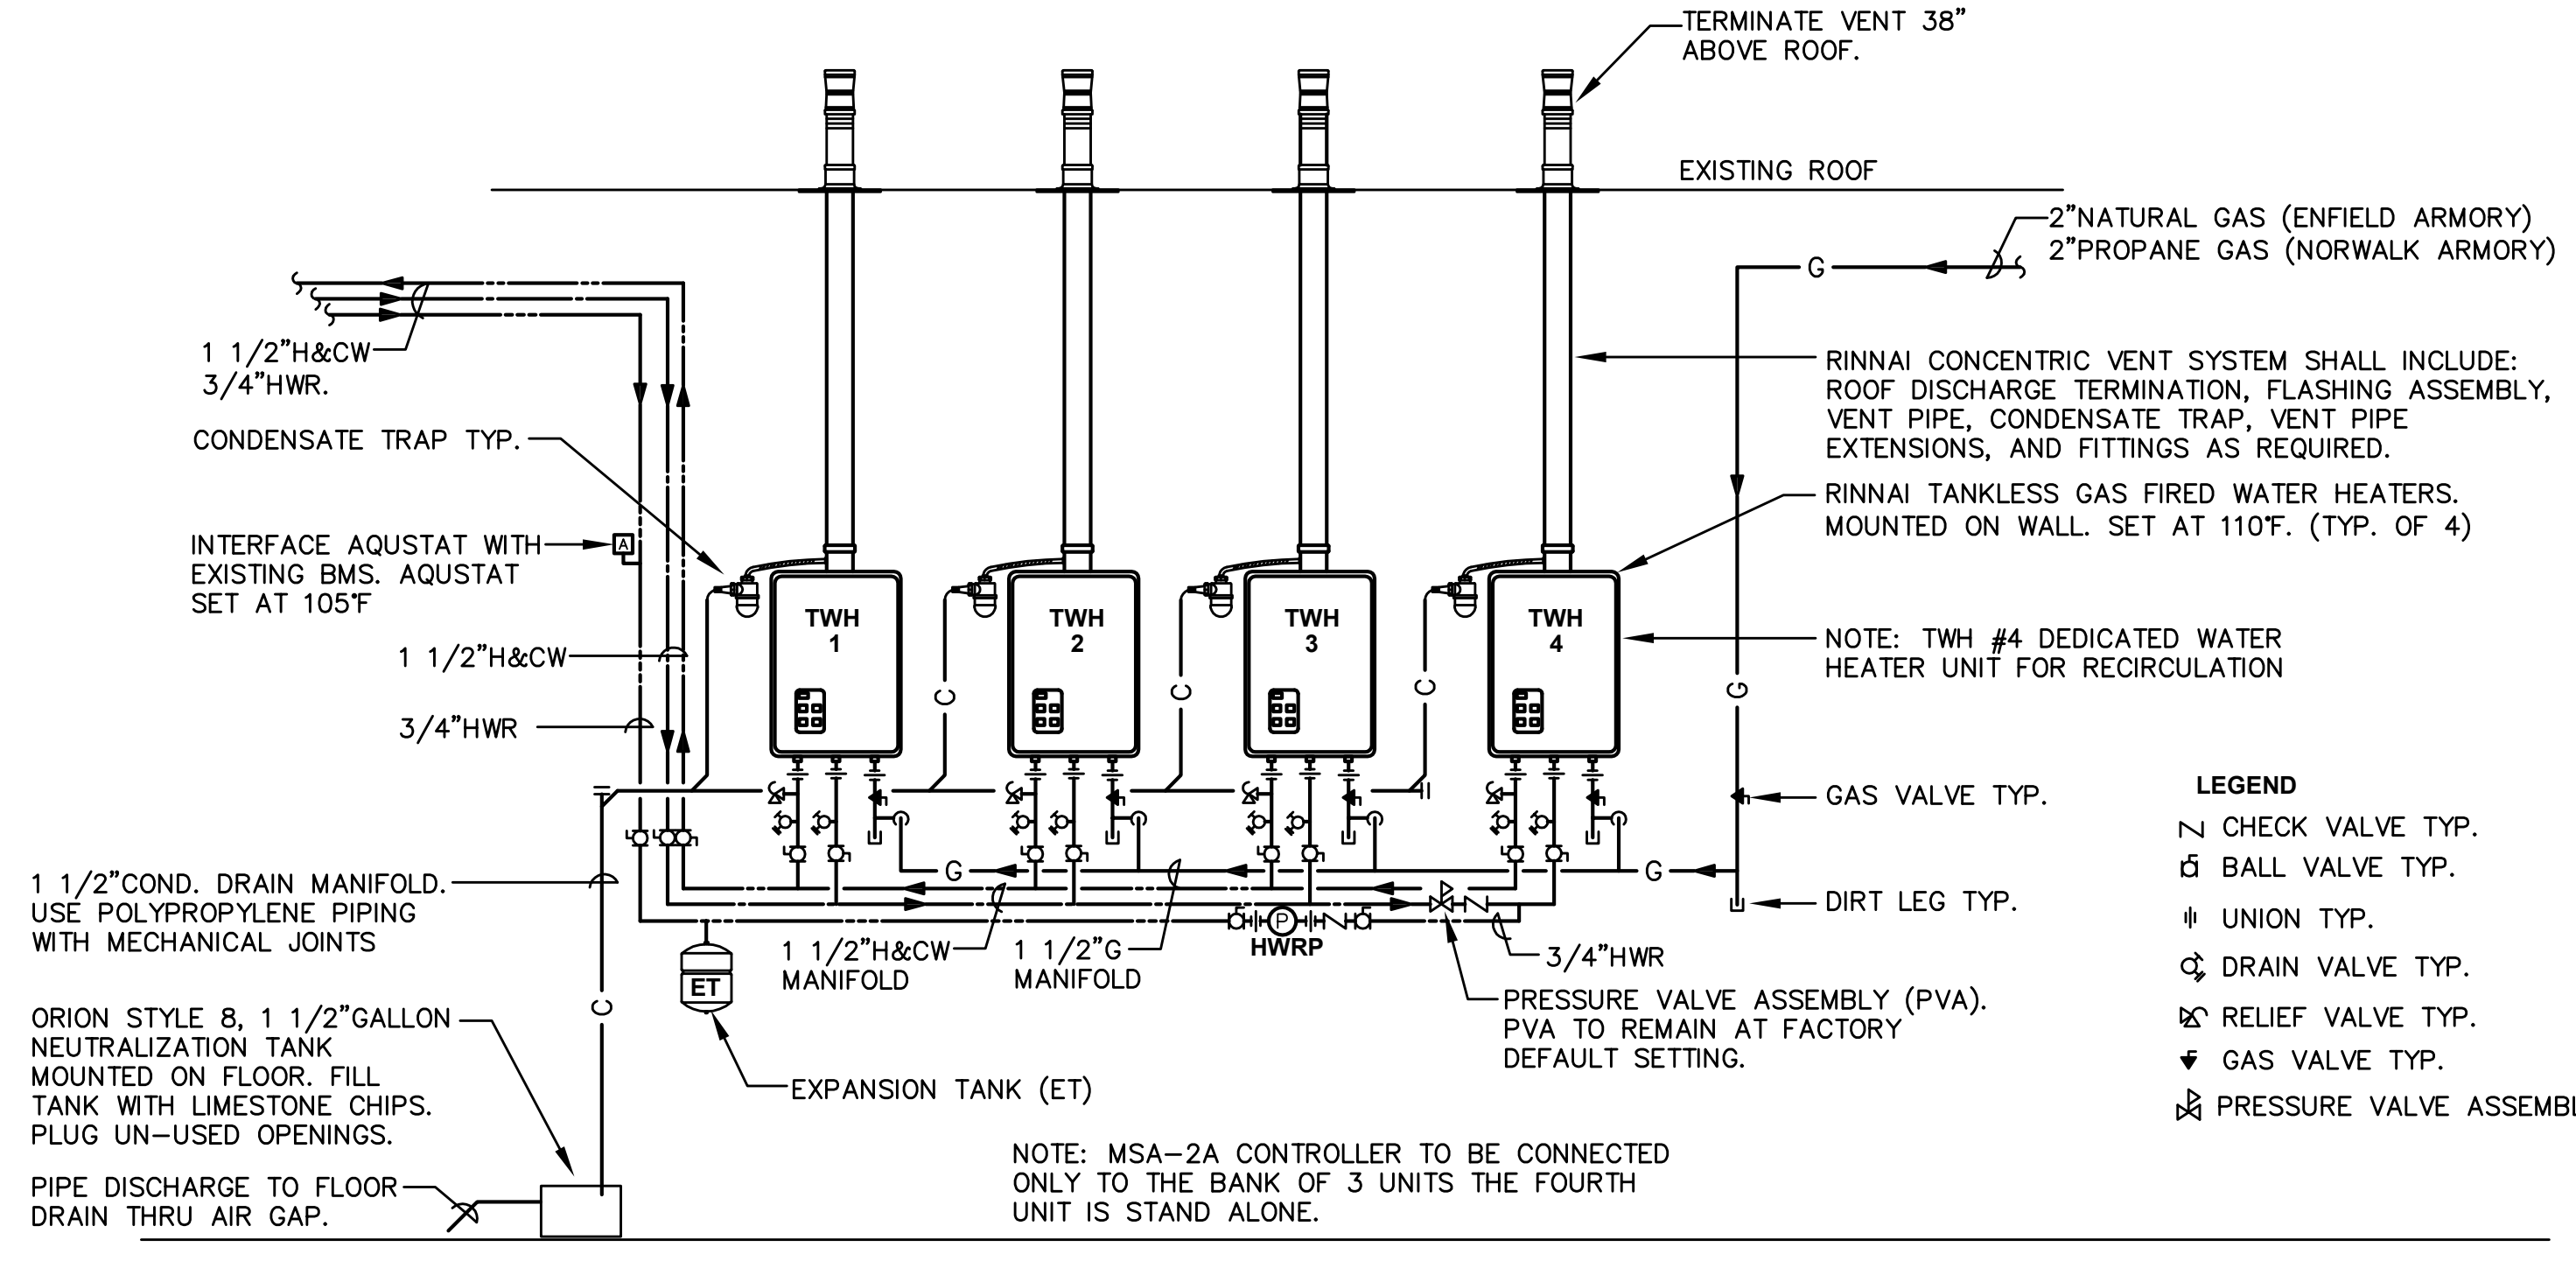

**DOMESTIC HOT WATER SYSTEM SCHEMATIC PIPING DETAIL**  
NOT TO SCALE

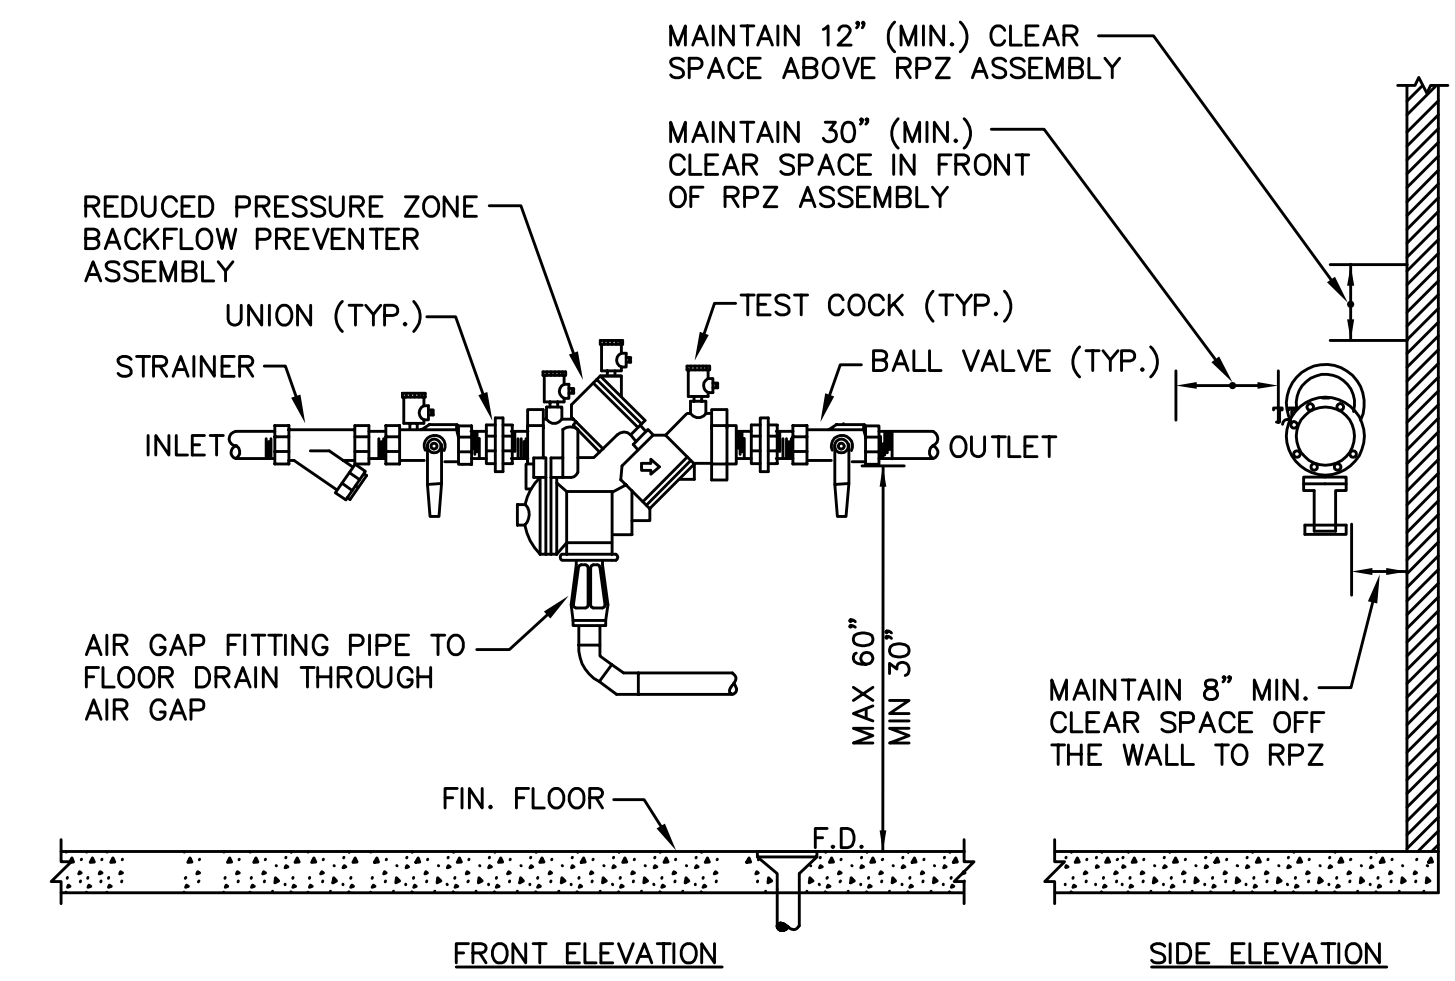

**TYPICAL BACKFLOW PREVENTER INSTALLATION DETAIL**  
NOT TO SCALE

**NOTES:**  
1. THE RPZ MOUNTING HEIGHT AND CLEARANCES INDICATED ABOVE SHALL BE MAINTAINED FOR PROPER ACCESS TO UNIT FOR TESTING, MAINTENANCE, AND INSPECTION PURPOSES.  
2. THE ASSEMBLY SHALL BE ADEQUATELY SUPPORTED AND/OR RESTRAINED TO PREVENT LATERAL MOVEMENT. PIPE HANGERS, BRACES, SADDLES, STANCHIONS, PIERS, ETC., SHALL BE USED TO SUPPORT THE DEVICE AND SHOULD BE PLACED IN A MANNER THAT WILL NOT OBSTRUCT ACCESS TO THE TESTING PORTS OR VALVES.

**MILITARY PROJECT #11MIL217-2401**

	<b>MEP DETAILS</b>	<b>STATE OF CONNECTICUT</b> DEPARTMENT OF PUBLIC WORKS
	<b>REVISIONS</b>	drawings prepared by BVH INTEGRATED SERVICES 50 GRIFFIN ROAD SOUTH, BLOOMFIELD, CT 06002
mark    date    description	drawings prepared by BVH INTEGRATED SERVICES 50 GRIFFIN ROAD SOUTH, BLOOMFIELD, CT 06002	date 02/28/2011 scale NONE
CAD no.	project no. 81-Q-644	drawn by GSK, MEL, JCK approved by CVD drawing no. <b>MEP-2.0</b>

ENFIELD ARMOY - PANELBOARD SCHEDULE													
<b>GENERAL NOTES:</b>													
1. SEE SPECIFICATION SECTION "PANELBOARDS" FOR FEATURES OF PANELBOARDS.													
2. VERIFY SIZE, QUANTITY AND TYPES OF CIRCUIT BREAKERS IN PANELBOARDS WITH PLANS, RISERS, SCHEDULES AND SPECIFICATION.													
3. ALL PANELBOARDS ARE LIGHTING AND APPLIANCE BRANCH CIRCUIT PANELBOARDS UNLESS LISTED OTHERWISE.													
PANELBOARD DESIGNATION	VOLTAGE	MAIN BUS SIZE	MAIN OCPD SIZE	MOUNTING	POLE CAPACITY	MIN. AISC RATING	NOTES	CIRCUITS					
								AMPS	POLES	BRANCH	FEEDER	SPARE	NOTES
LLP-MECH	208Y/120	225A	125A	SURFACE	42	10,000		20	1	10	-	5	
								20	3	-	2		
								40	3	-	2		
<b>NOTES:</b>													
A. TVSS PANELBOARD.													
B. DISTRIBUTION PANELBOARD.													
C. PROVIDE PANELBOARD WITH ISOLATED EQUIPMENT GROUND BUS BAR.													
D. PROVIDE PANELBOARD WITH STAINLESS STEEL TRIM AND DOOR.													
E. PROVIDE PANELBOARD WITH INTEGRAL LIGHTING CONTACTOR.													
F. PROVIDE PANELBOARD WITH AUXILIARY GUTTER.													
G. PROVIDE 30 MA GROUND FAULT CIRCUIT INTERRUPTER CIRCUIT BREAKERS.													
H. PROVIDE 5 MA GROUND FAULT CIRCUIT INTERRUPTER CIRCUIT BREAKERS.													

ENFIELD ARMOY- ELECTRICAL REQUIREMENTS FOR PLUMBING EQUIPMENT							
TAG	VOLTAGE-Ø	WATTS	AMPS	HOMERUN	BRANCH CIRCUIT SIZE	SWITCH SIZE	NOTES
TWH	120/1	80		20A-1P LLP-MECH	2#12+1#12GND,3/4"C	1	2
HWRP	120/1		.80	20A-1P LLP-MECH	2#12+1#12GND,3/4"C	1	
<b>SCHEDULE NOTES</b>							
1 PROVIDE MOTOR RATED TOGGLE SWITCH							
2 ALL FOUR (4) TANKLESS WATER HEATERS (TWH) SHALL BE WIRED TO A SINGLE 20A-1P POWER CIRCUIT							

NORWALK ARMOY- ELECTRICAL REQUIREMENTS FOR PLUMBING EQUIPMENT							
TAG	VOLTAGE-Ø	WATTS	AMPS	HOMERUN	BRANCH CIRCUIT SIZE	SWITCH SIZE	NOTES
TWH	120/1	80		20A-1P EXISTING PANEL	2#12+1#12GND,3/4"C	1	2
HWRP	120/1		.80	20A-1P EXISTING PANEL	2#12+1#12GND,3/4"C	1	
<b>SCHEDULE NOTES</b>							
1 PROVIDE MOTOR RATED TOGGLE SWITCH							
2 ALL FOUR (4) TANKLESS WATER HEATERS (TWH) SHALL BE WIRED TO A SINGLE 20A-1P POWER CIRCUIT							

FUEL-FIRED WATER HEATERS			
TYPE	EQUIPMENT	DESCRIPTION	REMARKS
"TWH"	TANKLESS GAS WATER HEATER	ENFIELD ARMOY - RENNAI #R98HPI-NG, (TYPICAL OF 4 HEATERS) NORWALK ARMOY - RENNAI #R98HPI-LP, (TYPICAL OF 4 HEATERS)  TANKLESS WATER HEATER(S) SHALL BE INTERNALLY MOUNTED, CONDENSING, INSTANTANEOUS, MULTIPLE POINT-OF-USE, GAS FIRED, DIRECT VENT, WATER HEATER(S) DESIGN CERTIFIED TO THE ANSI Z21.10.3 STANDARD FOR GAS FIRED WATER HEATERS. HEATERS SHALL INCLUDE MANIFOLD CONTROL PACK/PANEL, MANIFOLD WIRING HARNESS, RINNAI POLYPROPYLENE VENT SYSTEM, PRESSURE VALVE ASSEMBLY, CONDENSATE TRAP, PLUMBING INSTALLATION KIT, ETC.  EACH WATER HEATER SHALL PRODUCE NO MORE THAN 55 PPM NOX EMISSIONS WHEN TESTED IN ACCORDANCE WITH THE RULES AND REGULATIONS OF THE SOUTH COAST AIR QUALITY MANAGEMENT DISTRICT (SCAQMD).  WATER HEATER(S) SHALL BE CONFIGURED TO OPERATE WITH NATURAL GAS FOR "ENFIELD ARMOY" AND PROPANE GAS FOR "NORWALK ARMOY". WATER HEATER(S) SHALL HAVE A BTU INPUT RANGE OF AS FOLLOWS: 9,500 BTU/HR TO 199,000 BTU/HR NATURAL GAS, (ENFIELD ARMOY) 10,300 BTU/HR TO 199,000 BTU/HR PROPANE, (NORWALK ARMOY) A MINIMUM THERMAL EFFICIENCY RATING OF 96%, AND A MINIMUM HOT WATER OUTLET CAPACITY OF 9.8 GALLONS PER MINUTE (WITH A 30 °F TEMPERATURE RISE), AND A 120 VOLT/60 HZ AC POWER SOURCE.  WATER HEATER(S) SHALL BE MICROPROCESSOR CONTROLLED AND UTILIZE A DIRECT ELECTRONIC IGNITION SYSTEM (WITH NO STANDING PILOT), FULLY MODULATING GAS CONTROL VALVE, TURBINE FLOW METER, AUTOMATIC ELECTRO-MECHANICAL WATER FLOW CONTROL VALVE, AND WATER TEMPERATURE THERMISTORS TO MAINTAIN OUTLET WATER TEMPERATURE BETWEEN ± 2 °F OF SETPOINT TEMPERATURE.  WATER HEATER(S) SHALL INCORPORATE THE FOLLOWING INTERNAL SAFETY DEVICES: FLAME FAILURE LOCKOUT, BOILING PROTECTION LOCKOUT, THERMAL OVERHEAT PROTECTION, INTERNAL FREEZE PROTECTION FOR AMBIENT TEMPERATURES AS LOW AS -22 °F, AND LOCKOUT PROTECTION IN THE EVENT OF A BLOCKED FLUE.  WATER HEATER(S) SHALL BE PROVIDED WITH A TEMPERATURE THERMOSTAT WITH AN ADJUSTABLE SETPOINT RANGE OF 98 °F TO 140 °F. FOR COMMERCIAL AND RADIANT HEATING APPLICATIONS, AN MCC-91 CONTROLLER SHALL BE AVAILABLE WHICH SHALL BE CAPABLE OF PROVIDING AN ADJUSTABLE SETPOINT RANGE OF 98 °F TO 185 °F.  WATER HEATER(S) SHALL ALSO BE CAPABLE OF STORING AND DISPLAYING A HISTORY OF UP TO 9 DIAGNOSTIC MAINTENANCE CODES, VIA THE DISPLAY ON THE EMPEARTURE THERMOSTAT CONTROLLER.  WATER HEATER(S) SHALL HAVE STAINLESS STEEL BURNERS, SOLID BRASS WATER FLOW CONTROL VALVE, AND SOLID BRASS INLET AND OUTLET WATER CONNECTIONS.  WATER HEATER(S) SHALL HAVE A COPPER HEAT EXCHANGER WARRANTED AGAINST MATERIAL DEFECTS OR WORKMANSHIP FOR A PERIOD OF 12 YEARS FROM THE DATE OF PURCHASE, OR 5 YEARS FROM DATE OF PURCHASE WHEN USED IN A COMMERCIAL APPLICATION OR WITH THE MCC-91 CONTROLLER, OR 3 YEARS FROM DATE OF PURCHASE WHEN USED AS A CIRCULATING WATER HEATER WITHIN A HOT WATER CIRCULATION LOOP.  ALL OTHER PARTS SHALL BE WARRANTED AGAINST MATERIAL DEFECTS OR WORKMANSHIP FOR A PERIOD OF 5 YEARS FROM THE DATE OF PURCHASE OR 3 YEARS FROM DATE OF PURCHASE WHEN USED AS A CIRCULATING WATER HEATER WITHIN A HOT WATER CIRCULATION LOOP.  WATER HEATERS SYSTEM SHALL BE INSTALLED PER MANUFACTURER RECOMMENDATIONS AND INCLUDE FACTORY AUTHORIZED START UP. NOTE: IF CONTRACTOR SUBMITS ON ALTERNATE MANUFACTURER TO BASIS OF DESIGN: PIPING, PUMPING AND CONTROL SHALL BE PER MANUFACTURER'S RECOMMENDATIONS AT NO EXTRA COST TO THE OWNER.	

WATER DISTRIBUTION PUMPS SCHEDULE			
TYPE	EQUIPMENT	DESCRIPTION	REMARKS
"HWRP"	HOT WATER RETURN PUMP	BELL & GOSSETT #NBF-22, BRONZE BODY, HORIZONTAL LUBRICATED TYPE IN-LINE PUMP, SUITABLE FOR POTABLE WATER SERVICE, 225F OPERATION AT 150 PSIG WORKING PRESSURE AND SHALL BE UL LISTED. MOTOR SHALL HAVE BUILT-IN OVERLOAD PROTECTION. PUMP SHALL HAVE CAPACITY OF 5 GPM AT 12 FEET OF HEAD. RATED FOR .80 AMPS, 120V-1Ø	

EXPANSION TANKS SCHEDULE			
TYPE	EQUIPMENT	DESCRIPTION	REMARKS
"ET"	EXPANSION TANK	AMTROL "THERM-X-TROL" ST-12-C, 8 GALLON, 12" DIA X 16" HIGH, ASME PRECHARGED THERMAL EXPANSION TANK, WITH A HEAVY DUTY BUTYL BLADDER SUITABLE FOR DOMESTIC POTABLE WATER SYSTEM, ALL INTERNAL WETTED PARTS MUST COMPLY WITH FDA REGULATIONS. THE TANK SHALL HAVE A SYSTEM CONNECTION AND CHARGING VALVE TO FACILITATE THE ON-SITE CHARGING OF THE TANK TO MEET SYSTEM REQUIREMENTS. THE TANK MUST BE CONSTRUCTED IN ACCORDANCE WITH SECTION VIII OF THE ASME BOILER AND PRESSURE VESSEL CODE. RATED FOR 150 PSI WORKING PRESSURE AND 210° TEMPERATURE.	

PLUMBING WATER SPECIALTIES SCHEDULE			
ITEM	SPECIALTY ITEM	DESCRIPTION	REMARKS/ELECTRICAL
"RPZ"	BACKFLOW PREVENTER	WATTS #909QT-S, REDUCED PRESSURE BACKFLOW PREVENTER, ALL BRONZE BODY CONSTRUCTION WITH STRAINER & QUATER TURN BALL VALVES. #909AG FIXED AIR GAP.	PIPE RELIEF VALVE TO FLOOR DRAIN.

ENFIELD ARMOY - CONDENSING BOILER SCHEDULE									
TAG	MFR	MODEL	I-B-R		NATURAL GAS				
			NET	THERMAL EFFICIENCY	INPUT MIN. MBH	INPUT MAX. MBH	OUTPUT MBH	MINIMUM PRESSURE	
B-1	LOCHINVAR	SBN1000	818	94.1%	100	999	941	5 IN. WC	
B-2	LOCHINVAR	SBN1000	818	94.1%	100	999	941	5 IN. WC	
TAG	DESIGN PRESSURE (PSIG)	RELIEF VALVE SETTING (PSIG)	EWT (°F)	LWT (°F)	MAXIMUM WPD (FT)	AIR INLET (IN)	VENT OUTLET (IN)		
B-1	40	50	160	180	---	6	6		
B-2	40	50	160	180	---	6	6		
TAG	VOLTS/PHASE	HOMERUN	BRANCH CIRCUIT SIZE	SW/FUSE SIZE	REMARKS				
B-1	120/1	(2) 20A-1P LLP-MECH	3/4"C. - 2#12 & 1#12 GND.	TOGGLE					
B-2	120/1	(2) 20A-1P LLP-MECH	3/4"C. - 2#12 & 1#12 GND.	TOGGLE					
<b>GENERAL NOTES:</b>									
PROVIDE WITH CONDENSATE NEUTRALIZATION KIT.									
PROVIDE WITH DIRECT VENT HORIZONTAL SIDEWALL.									
IF CONTRACTOR SUBMITS ON ALTERNATE MANUFACTURER TO BASIS OF DESIGN: PIPING, PUMPING AND CONTROL SHALL BE PER MANUFACTURER'S RECOMMENDATIONS AT NO EXTRA COST TO THE OWNER.									

ENFIELD ARMOY - EXPANSION TANK SCHEDULE							
TAG	MFR	MODEL	MINIMUM ACCEPTANCE (GALLONS)	DIAMETER	HEIGHT	SERVES	REMARKS
XT-1	B&G	B-300	80	24	50	HW SYSTEM	


ENFIELD ARMOY - PUMP SCHEDULE						
TAG	MFR	TYPE	SERIES/SIZE MODEL NUMBER	MINIMUM EFFICIENCY	GPM	FT OF HEAD (TDH)
P-1A	B&G	IN-LINE	60 1-1/2x6-1/4	63%	55	31
P-1B	B&G	IN-LINE	60 1-1/2x6-1/4	63%	55	31
P-2A	B&G	IN-LINE	60 1-1/2x6-1/4	63%	55	31
P-2B	B&G	IN-LINE	60 1-1/2x6-1/4	63%	55	31
P-3	B&G	BASE MOUNTED	1510 2-1/2AB	70%	130	45
P-4	B&G	BASE MOUNTED	1510 2-1/2AB	70%	130	45

TAG	RPM	MOTOR HP	VFC	SERVES	OPERATION
P-1A	1750	1	NO	BOILER B-1	PRIMARY
P-1B	1750	1	NO	BOILER B-1	PRIMARY
P-2A	1750	1	NO	BOILER B-2	PRIMARY
P-2B	1750	1	NO	BOILER B-2	PRIMARY
P-3	1750	5	YES	HOT WATER HEATING SYSTEM	SECONDARY - RUN
P-4	1750	5	YES	HOT WATER HEATING SYSTEM	SECONDARY - STANDBY


TAG	VOLTS/PHASE	HOMERUN	BRANCH CIRCUIT SIZE	SW/FUSE SIZE	REMARKS
P-1A	208/3	20A-3P LLP-MECH	3/4"C. - 3#12 & 1#12 GND.	30/10	
P-1B	208/3	WIRE ON SAME CIRCUIT	3/4"C. - 3#12 & 1#12 GND.	30/10	
P-2A	208/3	20A-3P LLP-MECH	3/4"C. - 3#12 & 1#12 GND.	30/10	
P-2B	208/3	WIRE ON SAME CIRCUIT	3/4"C. - 3#12 & 1#12 GND.	30/10	
P-3	208/3	40A-3P LLP-MECH	3/4"C. - 3#12 & 1#12 GND.	60/40	
P-4	208/3	40A-3P LLP-MECH	3/4"C. - 3#12 & 1#12 GND.	60/40	
<b>GENERAL NOTES:</b>					
PROVIDE MAXIMUM IMPELLER DIAMETER FOR NON-OVERLOADING PERFORMANCE FOR SPECIFIED HORSEPOWER.					

ENFIELD ARMOY - UNIT HEATER SCHEDULE - HOT WATER										
TAG	MFR	MODEL	ARRANGE-MENT	MBH	EWT (°F)	LWT (°F)	GPM	PIPE RUNOUT SIZE (IN)	MAX WPD (FT)	FAN
UH-1	TRANE	UHSA-090-S	HORIZONTAL	45.3	180	160	4.7	1	.47	CFM HP RPM
										1214 1/8 1550
TAG	VOLTS/PHASE	HOMERUN	BRANCH CIRCUIT SIZE	SW/FUSE SIZE	REMARKS					
UH-1	120/1	20A-1P LLP-MECH	3/4"C. - 2#12 & 1#12 GND.	TOGGLE						
<b>GENERAL NOTES:</b>										
PROVIDE UNIT w/ FACTORY MOUNTED T'STAT.										


MILITARY PROJECT #11MIL217-2401

	<b>MEP SCHEDULES</b>	<b>STATE OF CONNECTICUT</b> DEPARTMENT OF PUBLIC WORKS	
	<b>REVISIONS</b>		drawings prepared by BVH INTEGRATED SERVICES 50 GRIFFIN ROAD SOUTH, BLOOMFIELD, CT 06002
mark date description	date description	project BOILER & HOT WATER HEATER UPGRADES ENFIELD & NORWALK ARMORIES ENFIELD & NORWALK, CT	date 02/28/2011 scale NONE drawn by GSK, MEL, JCK approved by CVD drawing no. <b>MEP-3.0</b>
CAD no.	project no.	project no.	81-Q-644



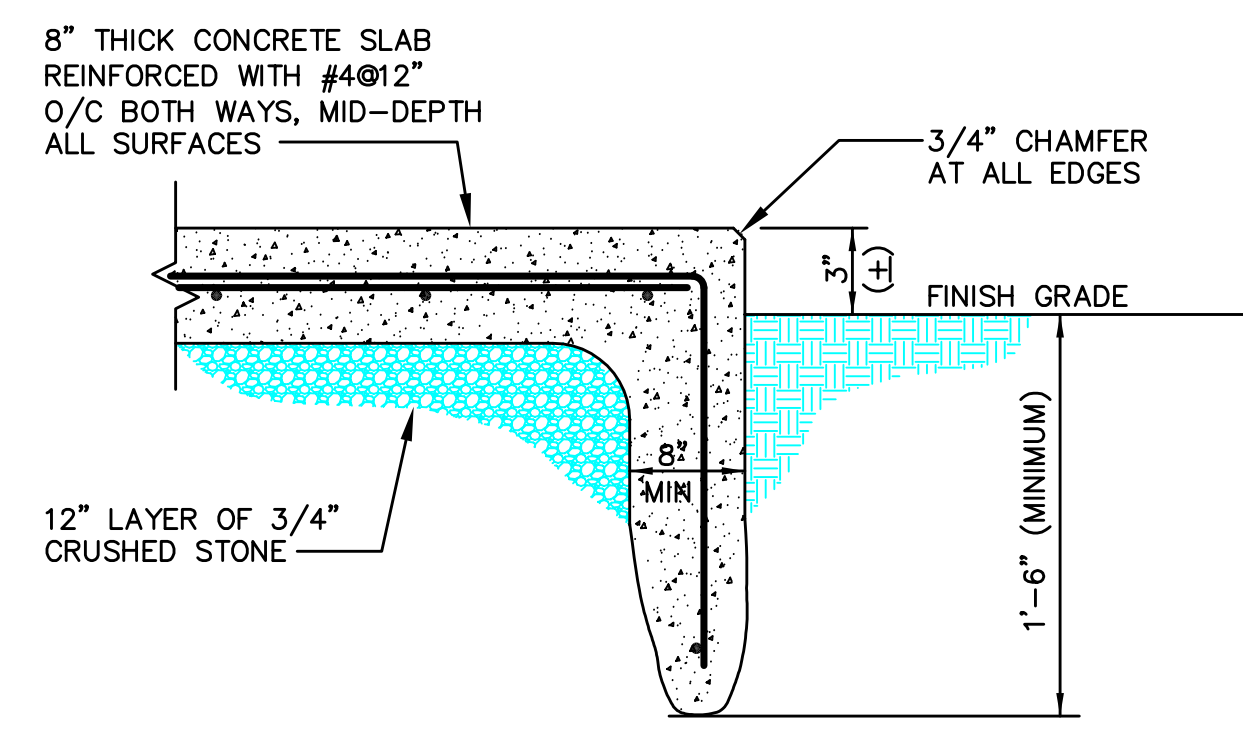


1 TYPICAL EQUIPMENT PAD DETAIL  
SU-1.0 NOT TO SCALE

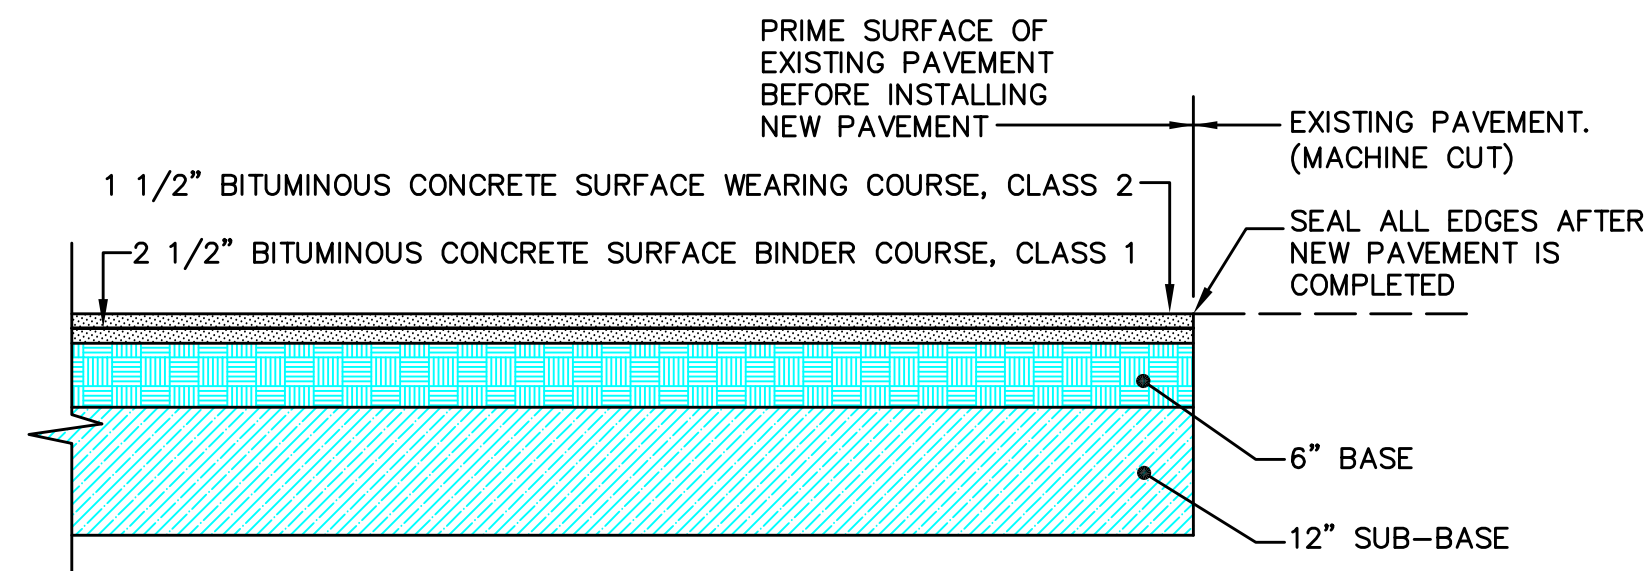


NOTE:  
CLASS 1 AND CLASS 2 BITUMINOUS CONCRETE MIXTURES SHALL COMPLY WITH CT FORM 816, LATEST EDITION.

2 TYPICAL NEW PAVEMENT SECTION  
SU-1.0 NOT TO SCALE

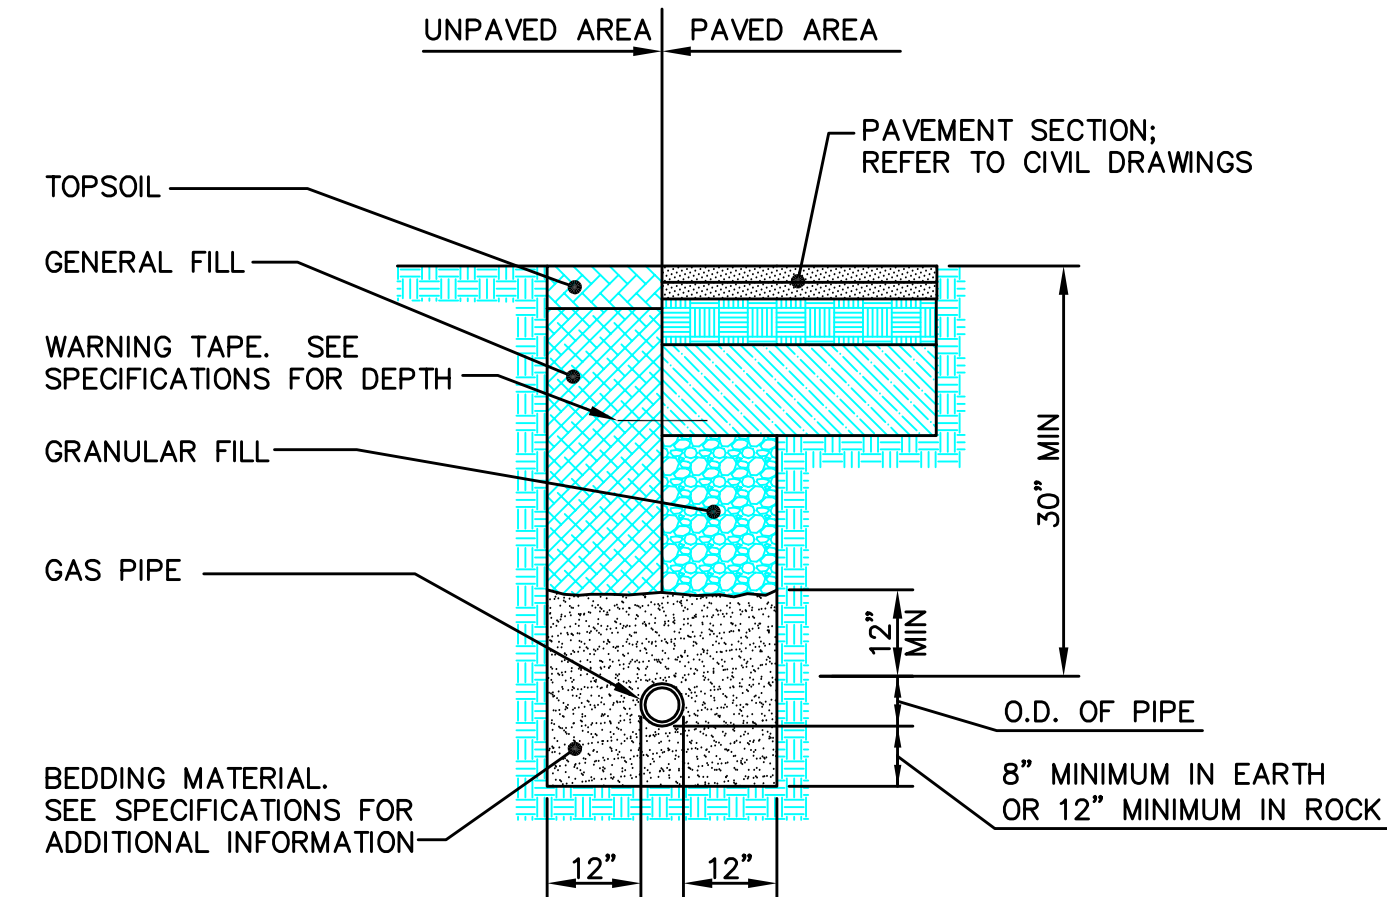


NOTE:  
1. SEE SPECIFICATION FOR BACKFILL, COMPACTION, AND SHORING REQUIREMENTS.

3 TYPICAL PIPE TRENCH SECTION  
SU-1.0 NOT TO SCALE

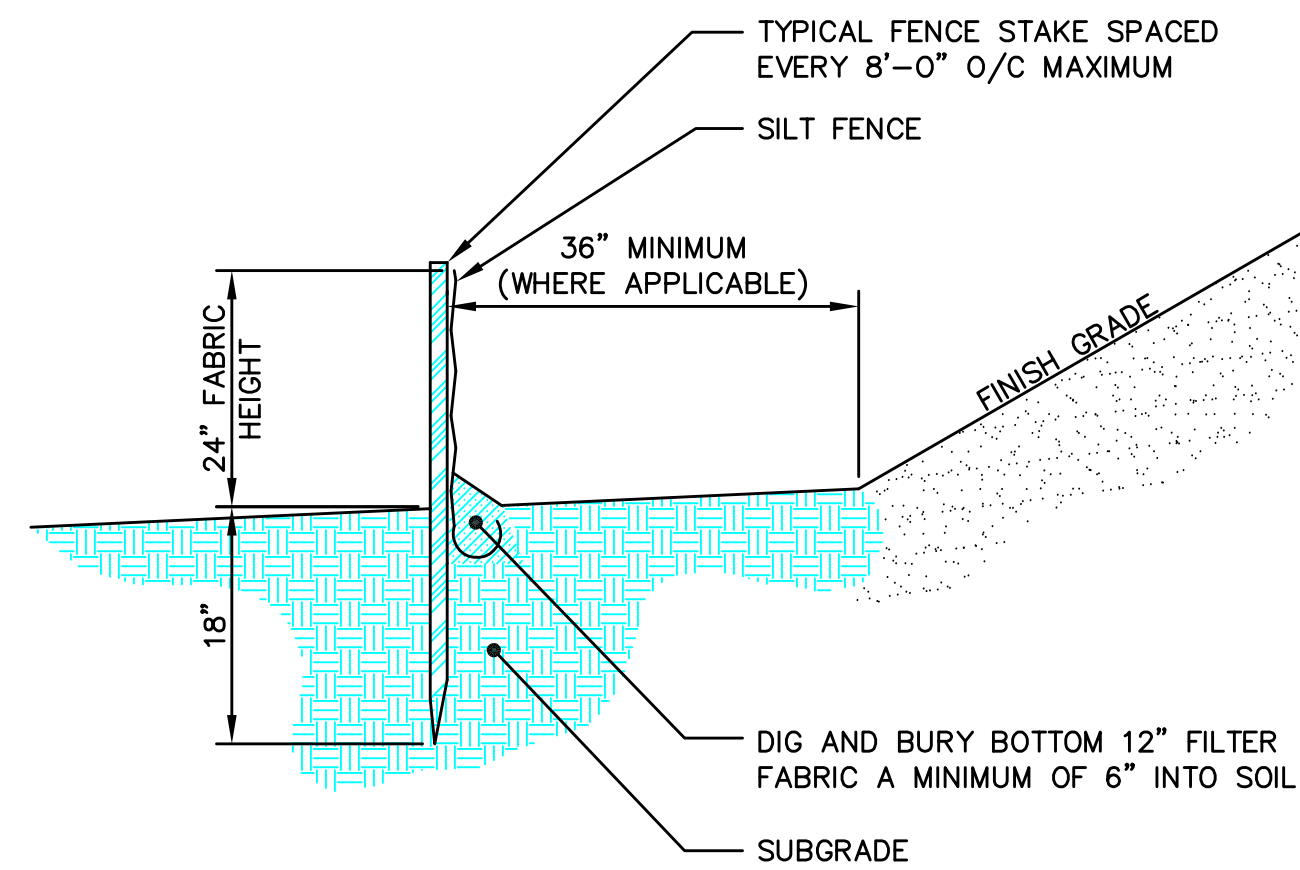

4 TYPICAL SILT FENCE  
SU-1.0 NOT TO SCALE

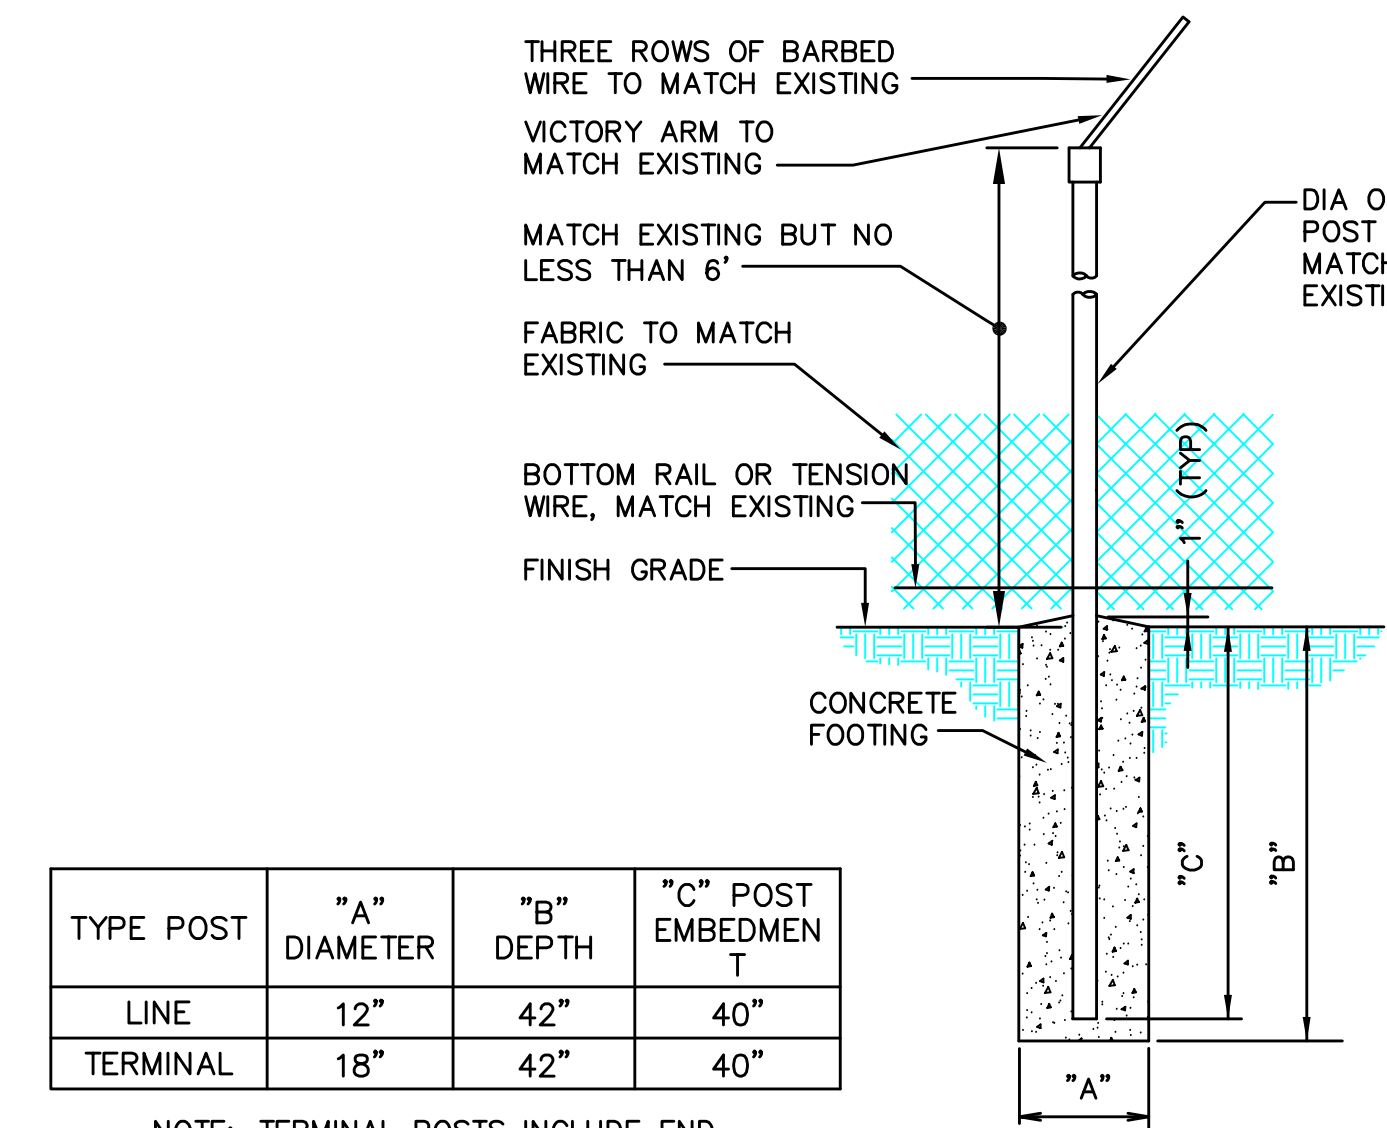


TYPE POST	"A" DIAMETER	"B" DEPTH	"C" POST EMBEDMENT
LINE	12"	42"	40"
TERMINAL	18"	42"	40"

NOTE: TERMINAL POSTS INCLUDE END, CORNER AND PULL POSTS

5 CHAIN LINK FENCE FOUNDATION DETAIL  
SU-1.0 NOT TO SCALE

**CIVIL GENERAL NOTES**

1. SURVEY IS NOT AVAILABLE. THE CONTRACTOR SHALL FIELD VERIFY EXISTING CONDITIONS PRIOR TO COMMENCEMENT OF NEW WORK. BVH INTEGRATED SERVICES ASSUMES NO RESPONSIBILITY FOR THE ACCURACY OF THE EXISTING CONDITIONS SHOWN NOR CHANGES TO THE WORK DUE TO ERROR IN THE EXISTING CONDITIONS SHOWN.
2. PRIOR TO COMMENCING CONSTRUCTION NOTIFY "CALL BEFORE YOU DIG" (1-800-922-4455) FOR FIELD LOCATION AND MARKING OF SUBSURFACE UTILITIES AT LEAST 72 HOURS IN ADVANCE BUT NO MORE THAN 30 DAYS. THE CONTRACTOR SHALL OBTAIN THE SERVICES OF A QUALIFIED UNDERGROUND UTILITY LOCATION FIRM, AT NO COST TO THE OWNER, TO VERIFY LOCATIONS OF UNDERGROUND UTILITIES.
3. ALL CONSTRUCTION METHODS SHALL CONFORM TO THE DRAWINGS AND SPECIFICATIONS AND ANY REFERENCED STANDARDS SUCH AS BUT NOT LIMITED TO THE FOLLOWING:
  - A. THE STATE OF CONNECTICUT DEPARTMENT OF TRANSPORTATION STANDARD SPECIFICATIONS FOR ROADS, BRIDGES AND INCIDENTAL CONSTRUCTION (FORM 816, AS AMENDED).
  - B. MATERIAL AND INSTALLATION SPECIFICATIONS OF EACH UTILITY COMPANY.
  - C. SPECIFIC CITY OF NORWALK REQUIREMENTS.
  - D. 2002 CONNECTICUT GUIDELINES FOR SOIL EROSION AND SEDIMENT CONTROL.
4. PROVIDE ALL NECESSARY SURVEY WORK REQUIRED FOR THE CONSTRUCTION STAKE-OUT AND PRODUCTION OF AS-BUILT PLANS. AS-BUILT PLANS SHALL SHOW LOCATION AND ELEVATION OF CONSTRUCTED BUILDINGS, STRUCTURES, EQUIPMENT, PIPING AND CONDUITS. CONTRACTOR TO PROVIDE RECORD DRAWINGS TO THE OWNER AT THE END OF THE PROJECT. REFER TO GENERAL CONDITIONS OF SPECIFICATIONS FOR REQUIREMENTS.
5. OBTAIN ALL NECESSARY PERMITS PRIOR TO THE COMMENCEMENT OF CONSTRUCTION.
6. IT IS THE RESPONSIBILITY OF THE CONTRACTOR TO DEVELOP THE CONSTRUCTION SCHEDULE AND PHASING, COORDINATE ALL ACTIVITIES WITH THE STATE OF CONNECTICUT AND THE CITY OF NORWALK AND NOTIFY ADJACENT PROPERTY OWNERS, AS REQUIRED. NOTIFY NECESSARY PARTIES AT LEAST 5 DAYS IN ADVANCE.
7. ALL EXISTING SITE UTILITIES WHICH ARE NOT INDICATED ON PLANS SHALL NOT BE INTERRUPTED FROM CONTINUOUS SERVICE. CONTRACTOR TO NOTIFY ENGINEER OF ANY CONFLICTS OR CONCERNS. EXISTING UTILITIES TO REMAIN ARE TO BE PROTECTED DURING CONSTRUCTION.
8. ESTABLISH AND MAINTAIN AT LEAST ONE BENCHMARKS ON SITE FOR VERTICAL AND HORIZONTAL CONTROL.
9. SAFETY ISSUES & HOURS OF OPERATION ARE THE RESPONSIBILITY OF THE CONTRACTOR AND ARE TO BE COORDINATED & APPROVED BY THE OWNER.

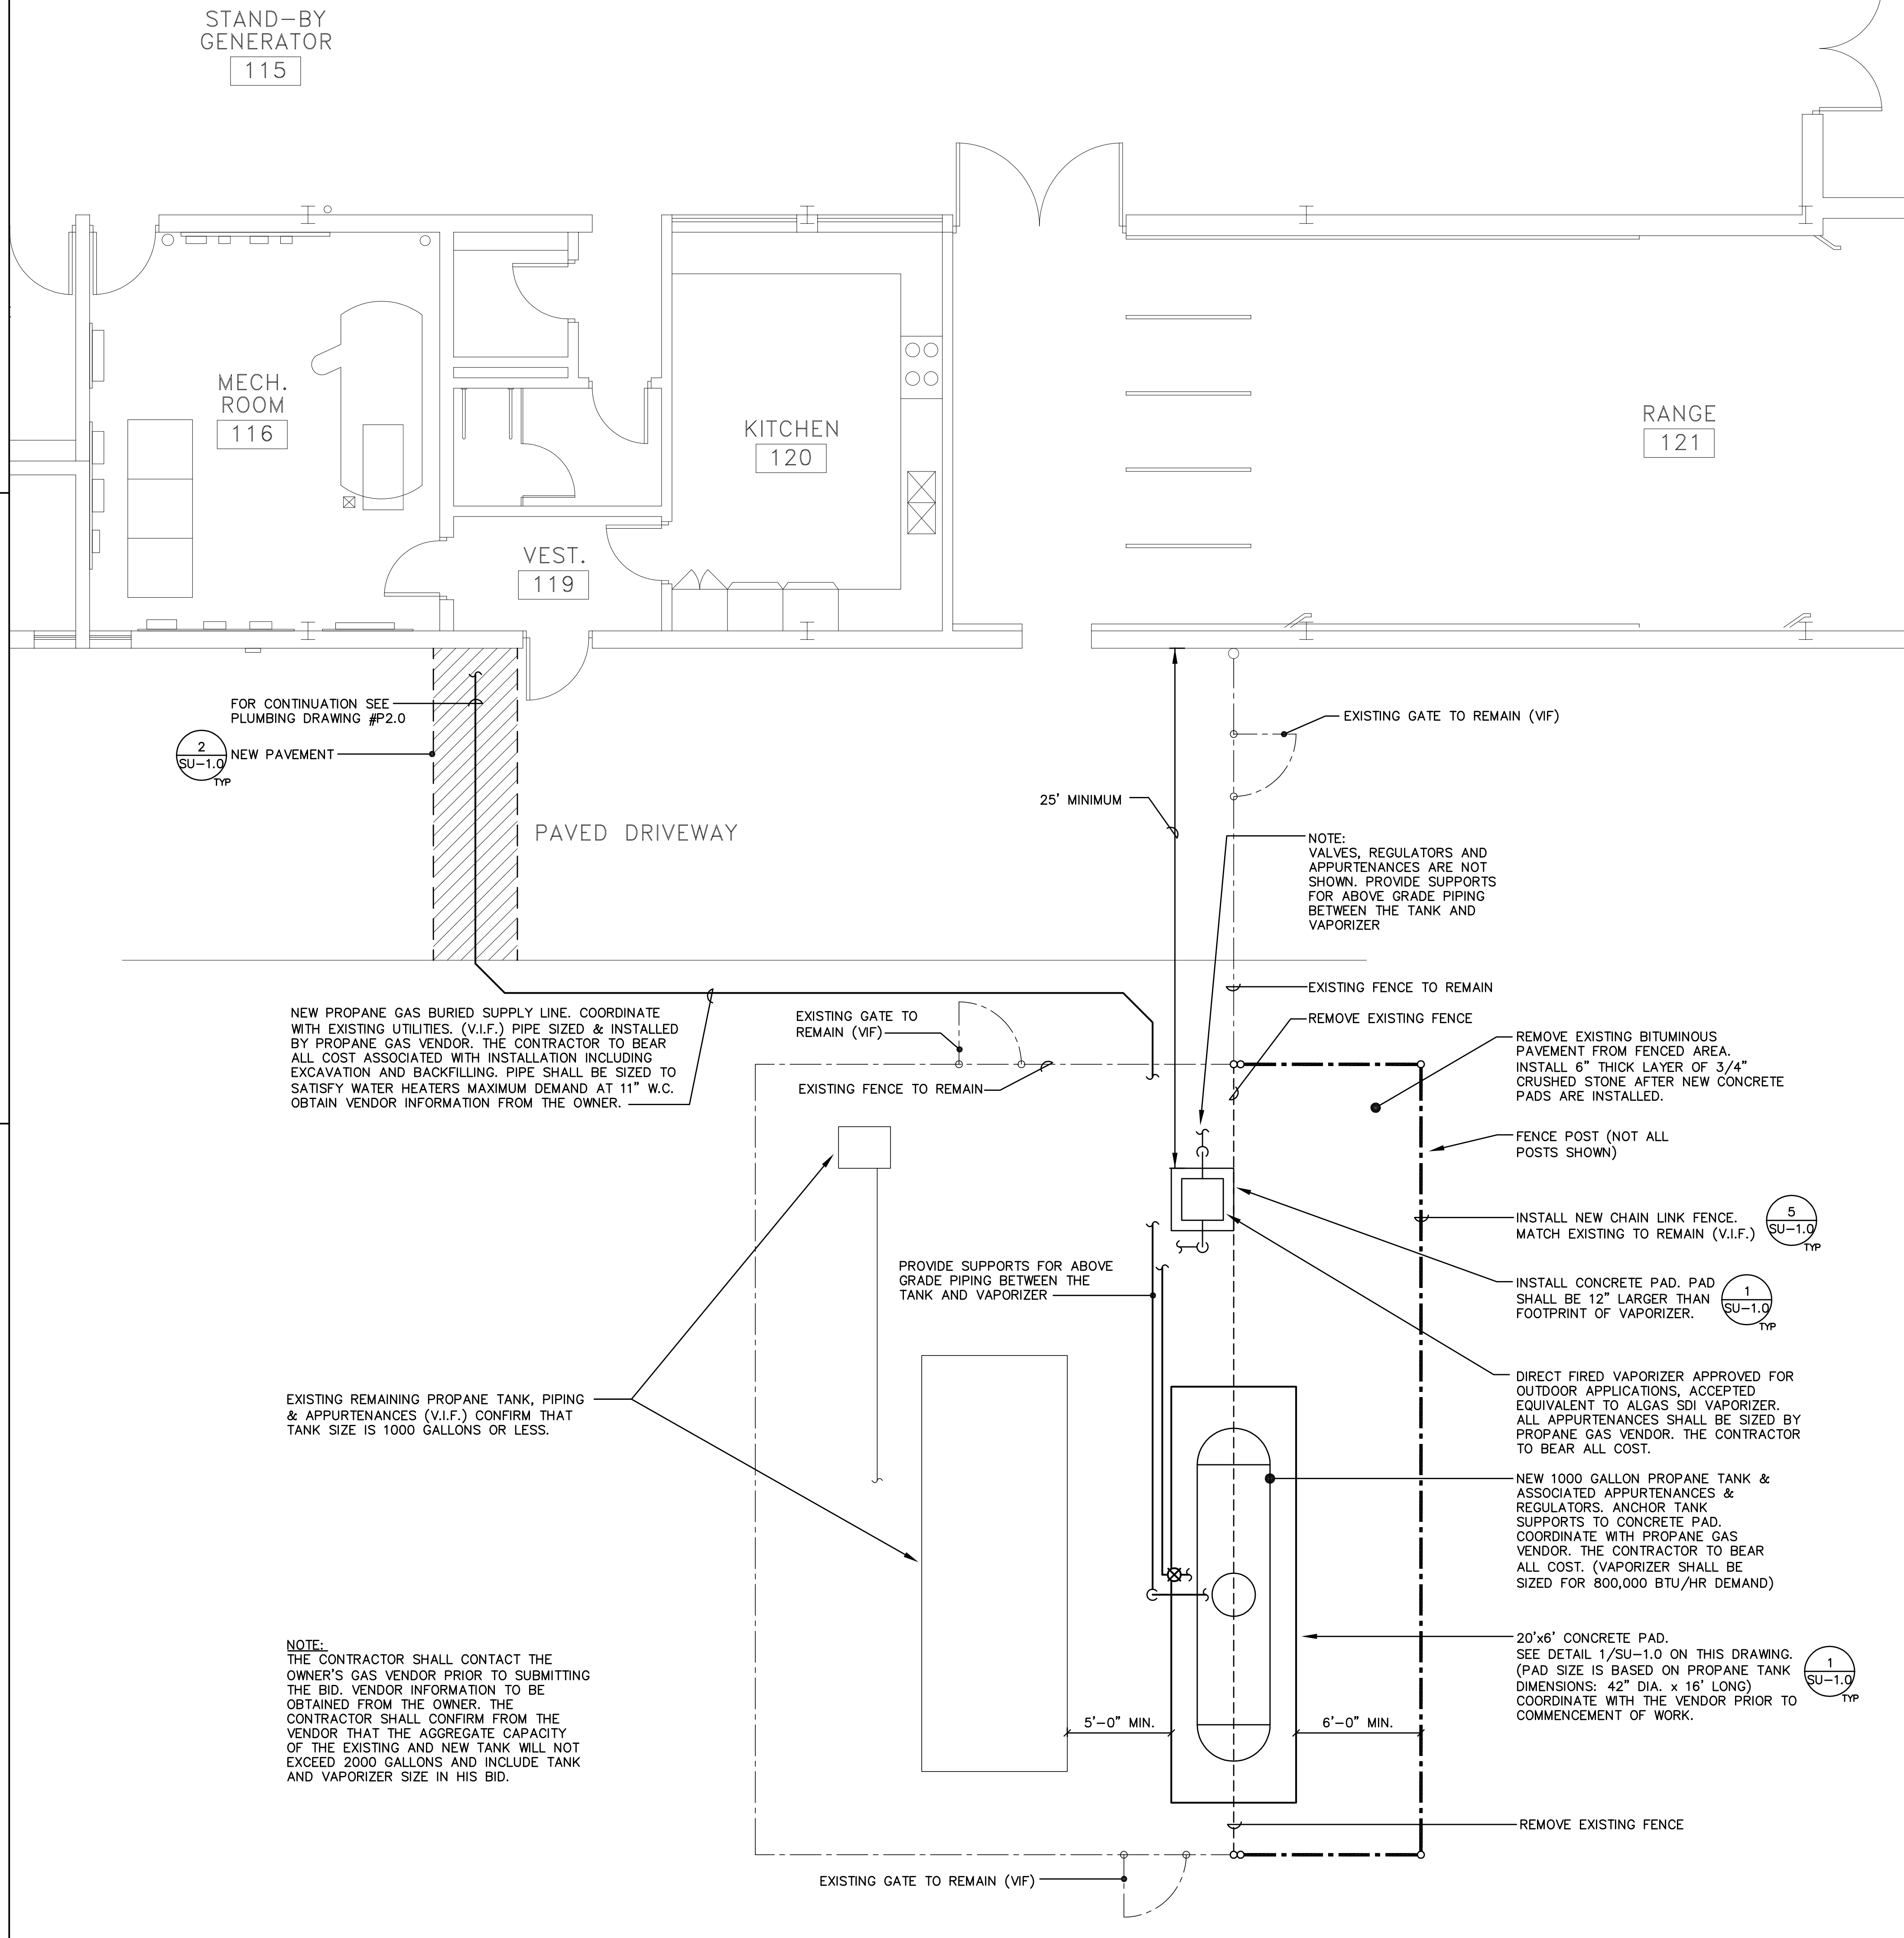

**NORWALK ARMORY - SITE PLAN**  
SCALE: 1/4"=1'-0"


MILITARY PROJECT #11MIL217-2401

NOTE:  
REFER TO MEP DRAWINGS FOR ADDITIONAL INFORMATION.


DRAWING TITLE		STATE OF CONNECTICUT	
NORWALK ARMORY - SITE PLAN		DEPARTMENT OF PUBLIC WORKS	
REVISIONS			
mark	date	description	
DRAWINGS PREPARED BY		DATE	
BVH INTEGRATED SERVICES		02/28/2011	
PROJECT		SCALE	
50 GRIFFIN ROAD SOUTH, BLOOMFIELD, CT 06002		1/4"=1'-0"	
DRAWN BY		APPROVED BY	
CA		CVD	
DRAWING NO.		SU-1.0	
PROJECT NO.		81-Q-644	

3/1/11 3:04:32 PM W:\2010\2110155 - Norwalk Armory Boiler And Water Heater Replacement\DWGS\F\SU-1.0.dwg



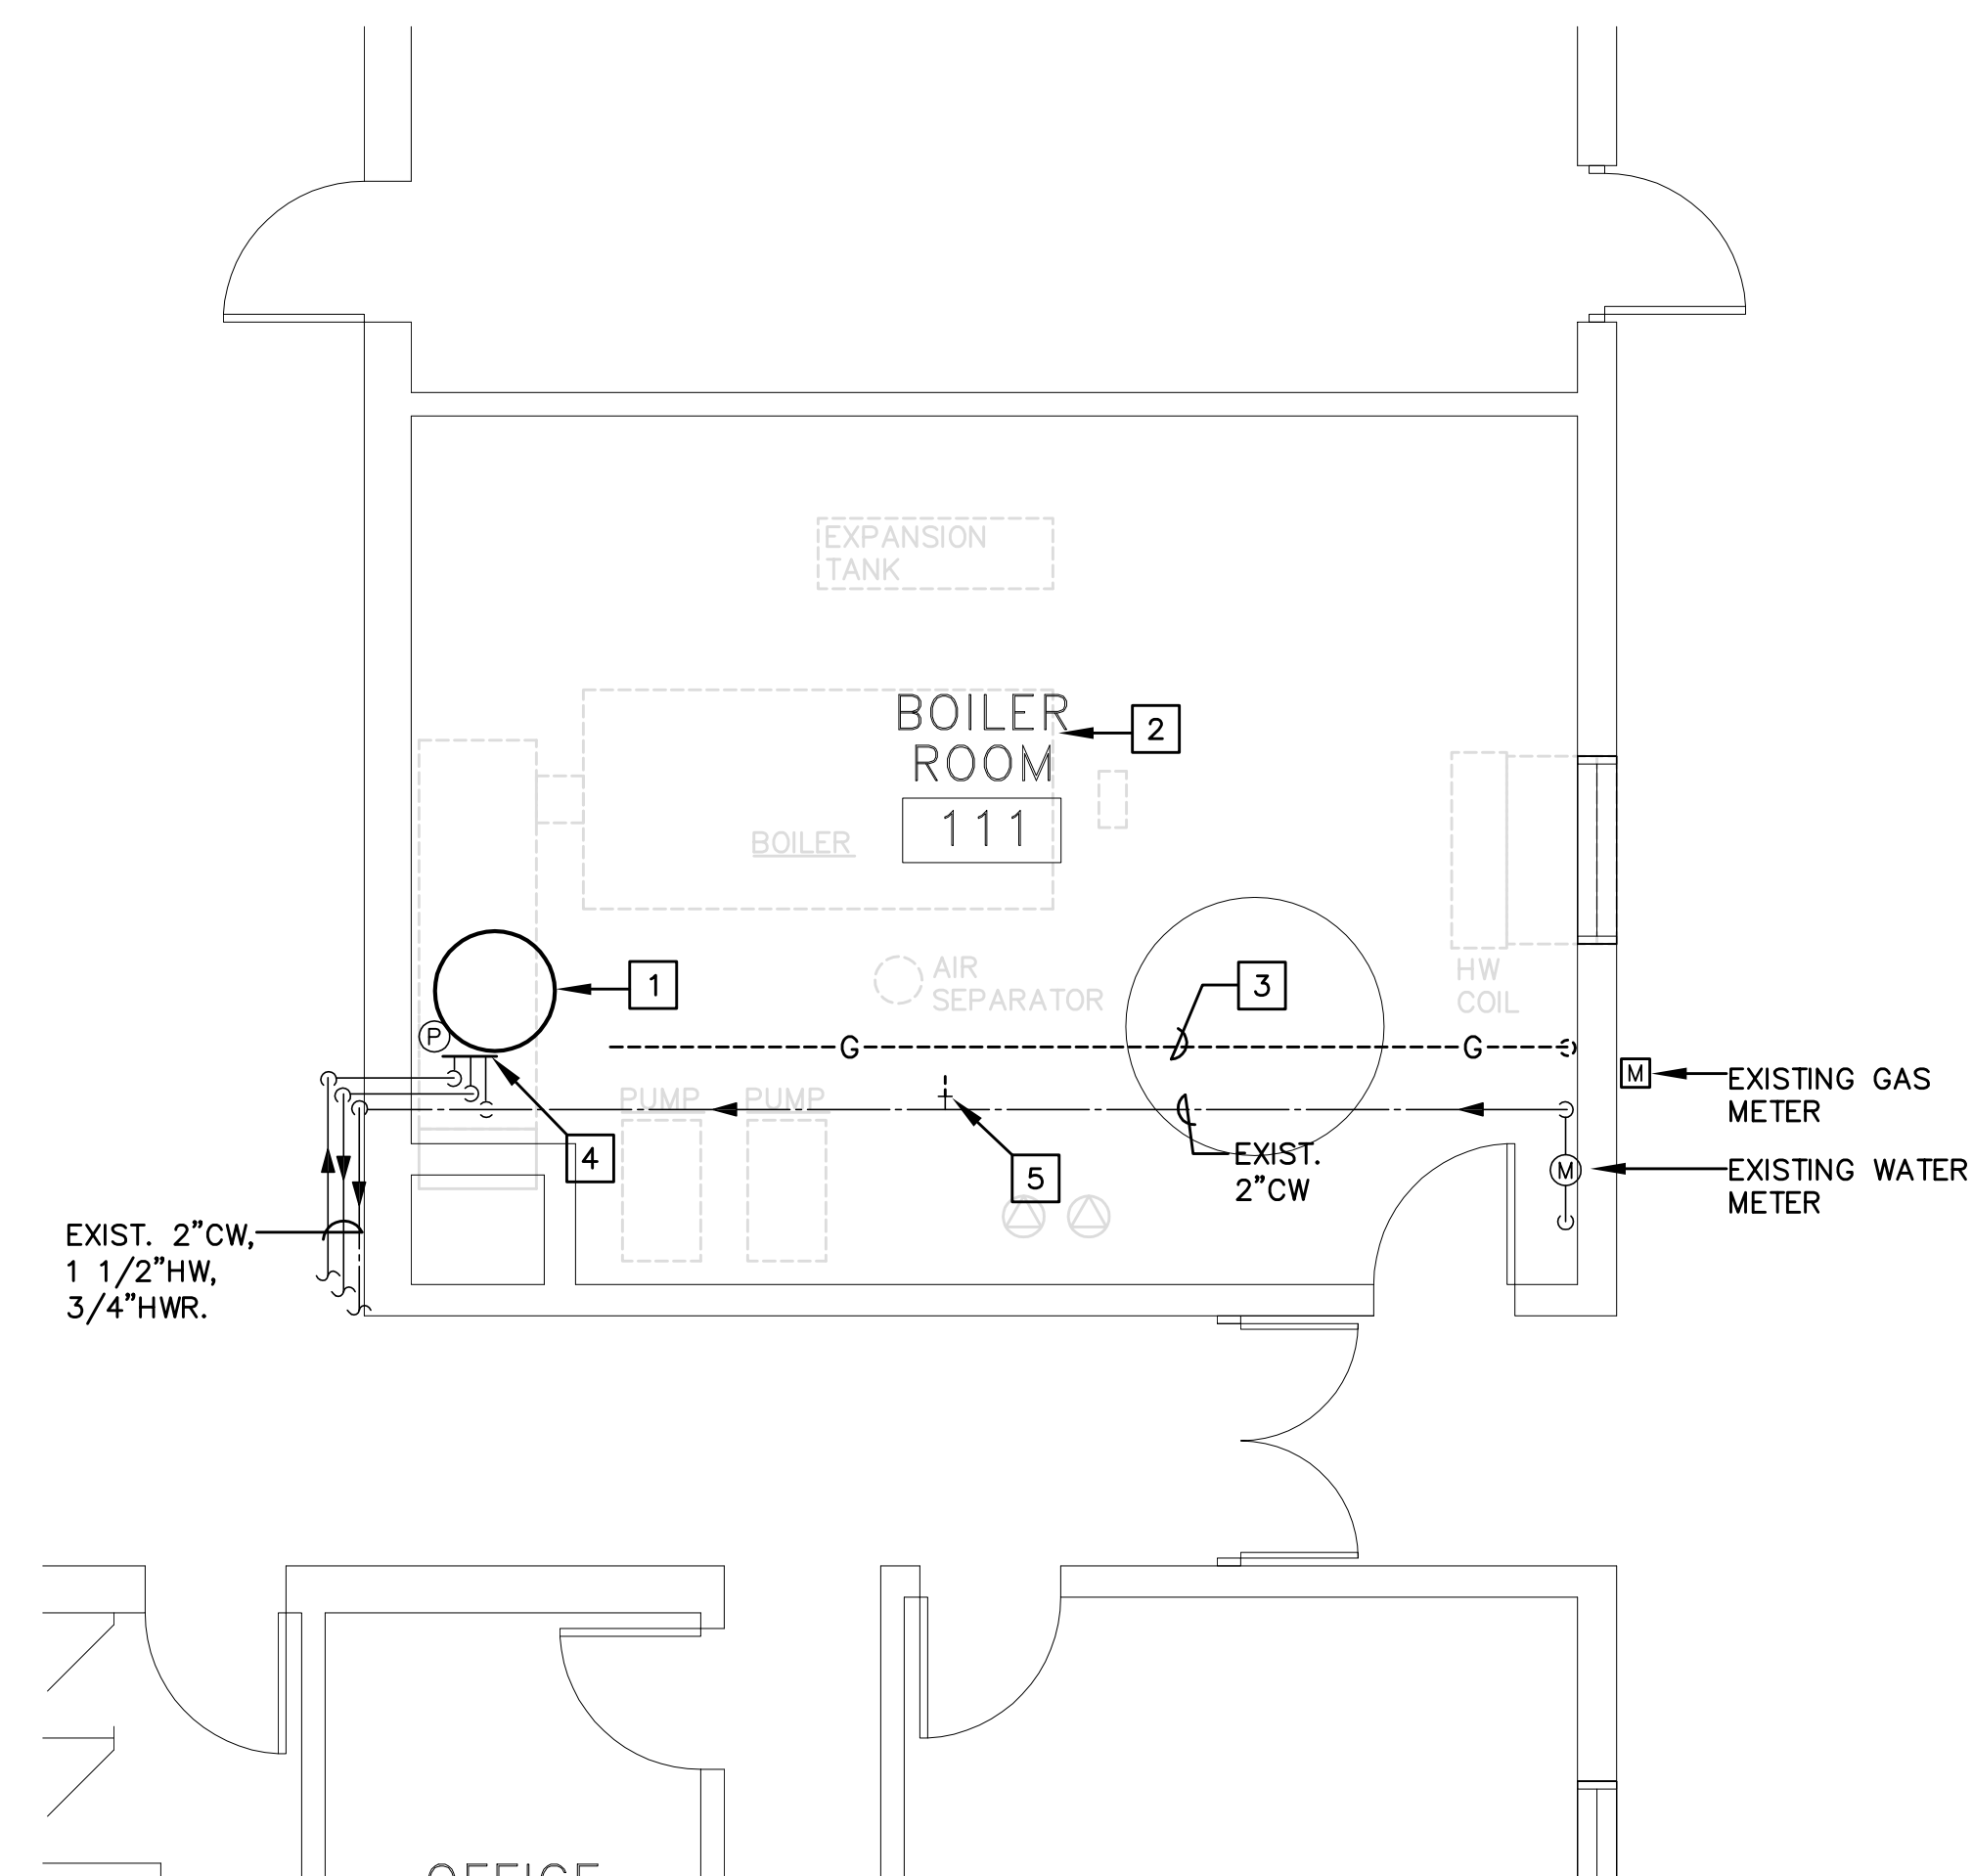

**ENFIELD ARMORY - PLUMBING DEMOLITION BOILER ROOM PART PLAN**  
SCALE: 1/4"=1'-0"

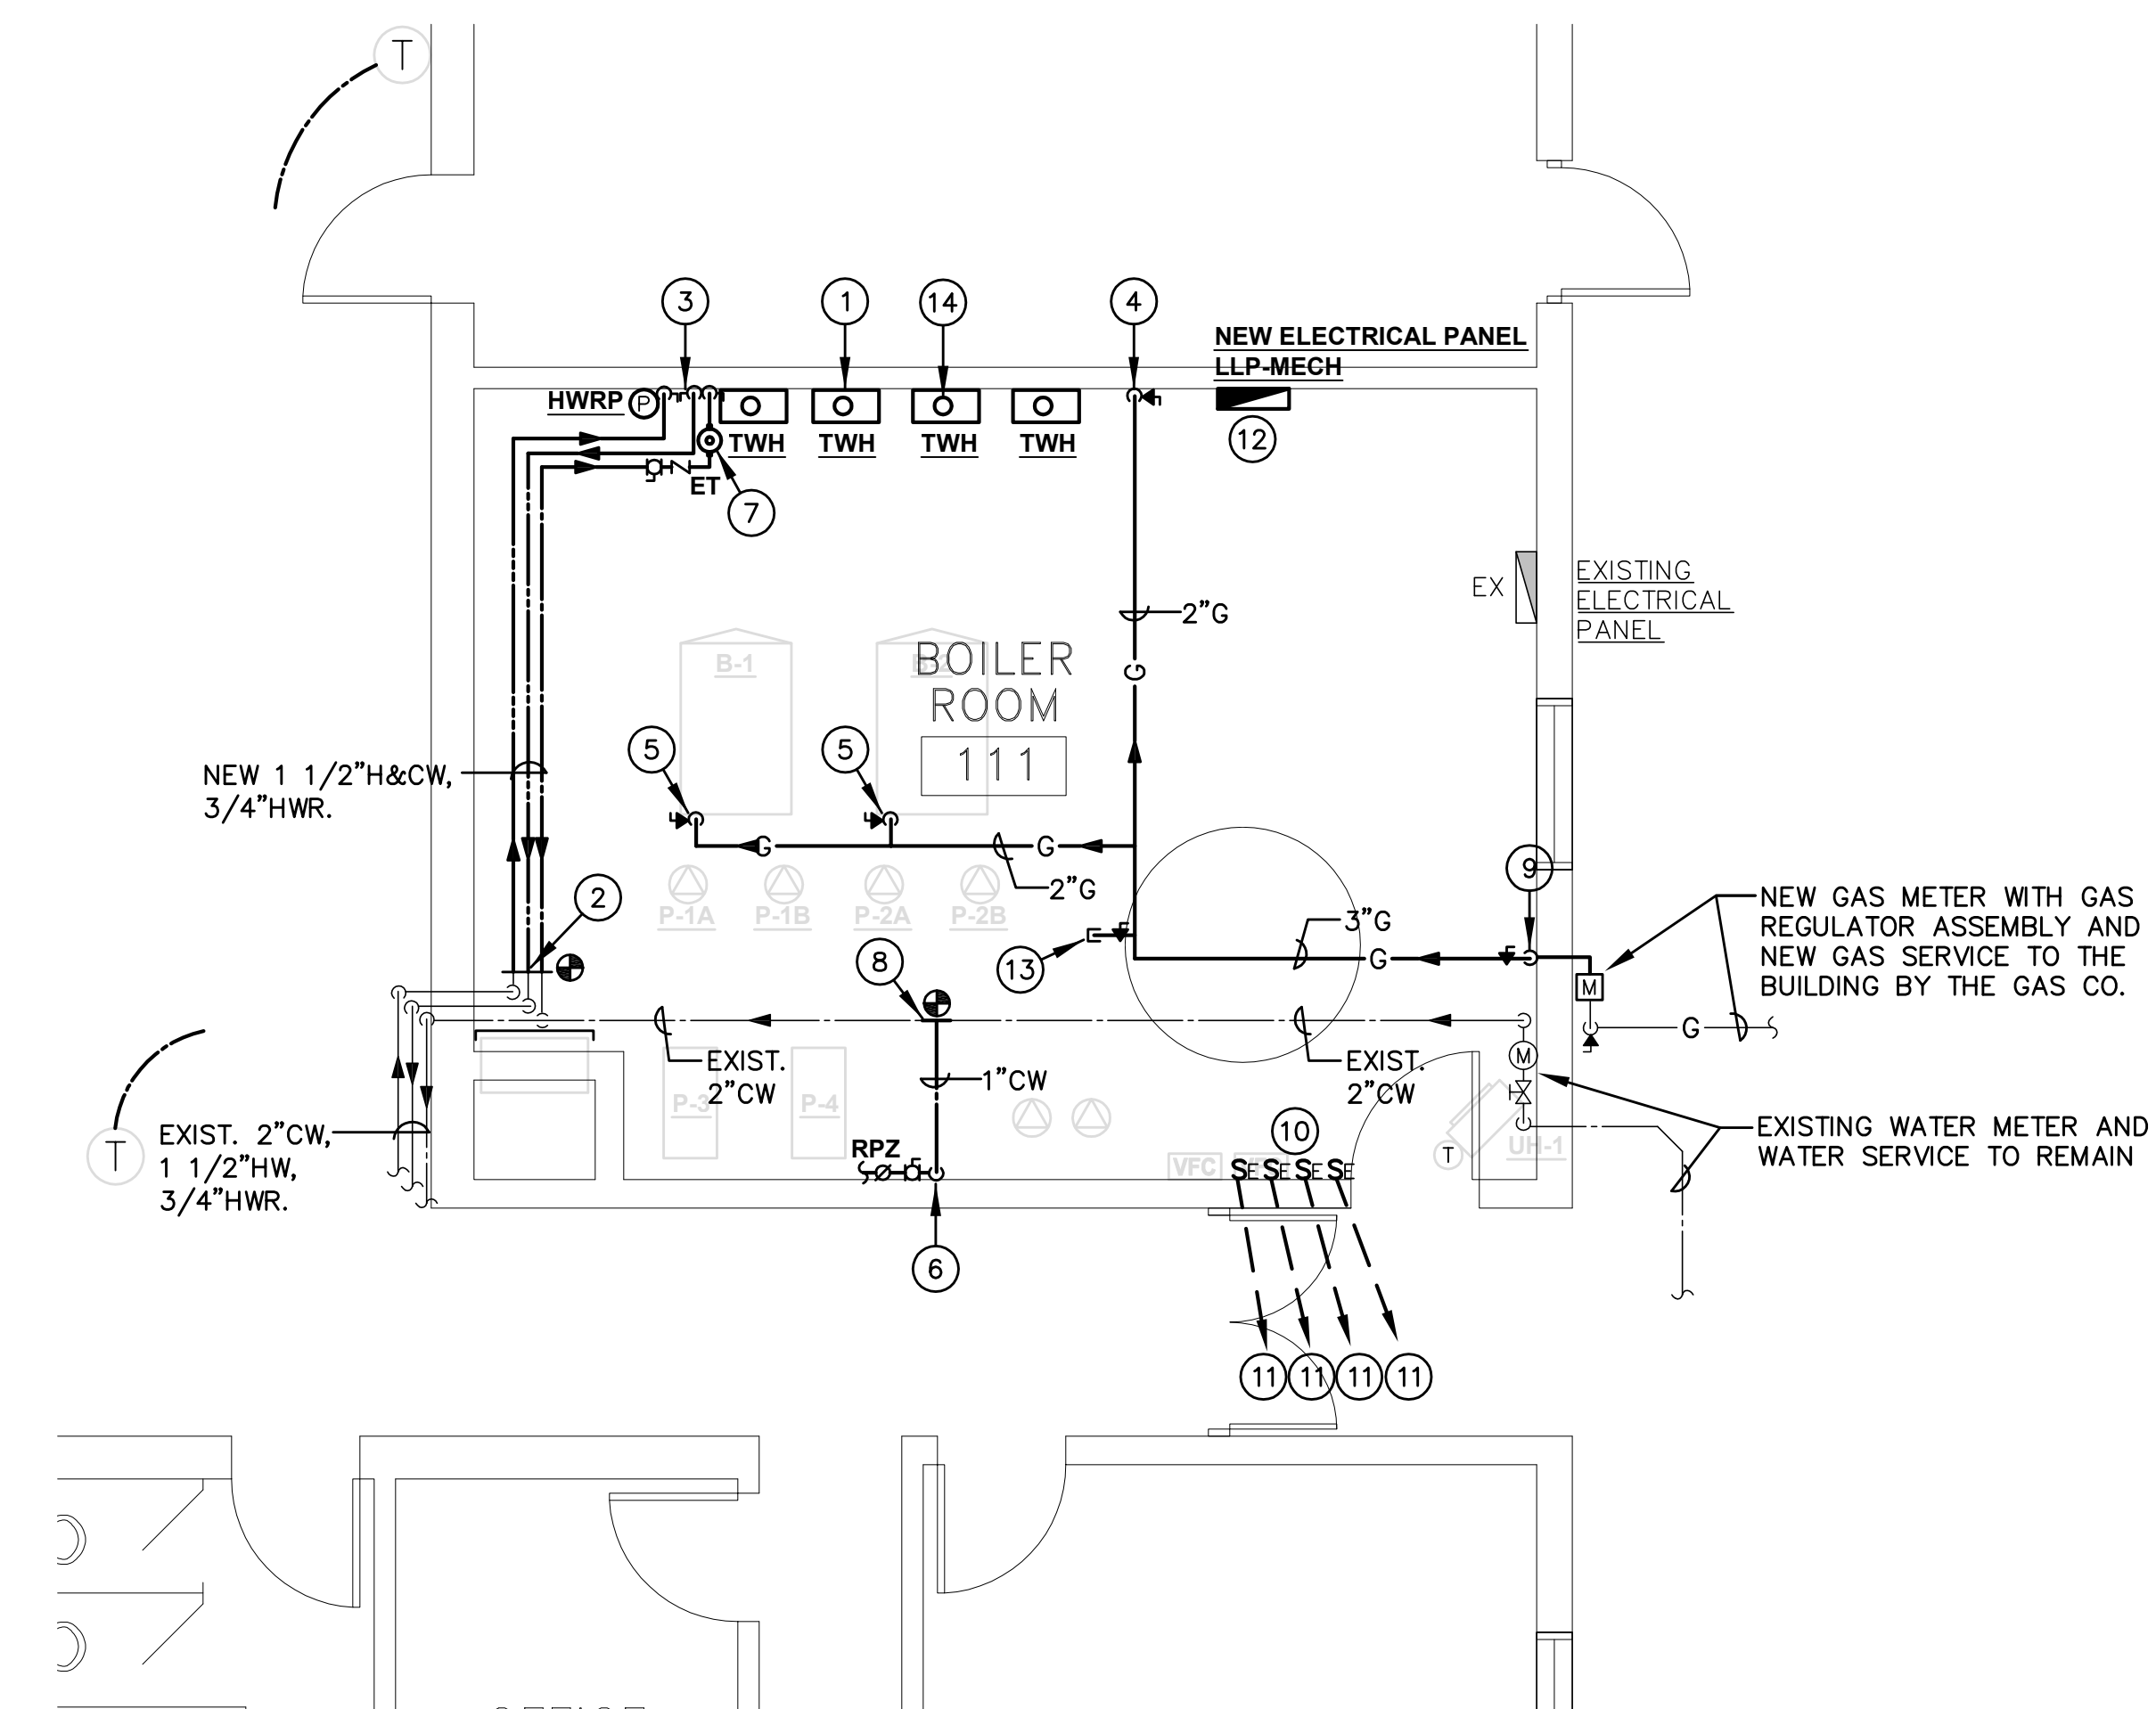

**ENFIELD ARMORY - PLUMBING BOILER ROOM PART PLAN**  
SCALE: 1/4"=1'-0"

**DEMOLITION NOTES**


- 1 REMOVE EXISTING GAS STORAGE TYPE WATER HEATER AND ASSOCIATED FLUE, PUMP, PIPING AND CONTROLS. PROVIDE ROOF DECK TO COVER FLUE OPENING. PATCH AND REPAIR ROOF TO MATCH EXISTING.
- 2 EXISTING BOILER TO BE REMOVED. DISCONNECT GAS AND COLD WATER MAKE-UP.
- 3 REMOVE EXISTING GAS PIPING UP TO GAS METER.
- 4 REMOVE EXISTING 1 1/2"H&CW, 3/4"HWR UP TO THIS POINT.
- 5 REMOVE EXISTING BACKFLOW PREVENTER AND COLD WATER MAKE-UP PIPING UP TO THIS POINT.


**DRAWING NOTES**

- 1 RINNAI (4) NEW TANKLESS GAS FIRED CONDENSING WATER HEATERS MOUNTED ON WALL. SEE RISER DIAGRAM ON DWG. #MEP-2.0 AND WATER HEATER SCHEDULE ON DWG. #MEP-3.0
- 2 CONNECT NEW 1 1/2"H&CW, 3/4"HWR DROP ON WALL TO EXISTING PIPING AND EXTEND TO NEW WATER HEATERS.
- 3 1 1/2"H&CW, 3/4"HWR DROP ON WALL TO TANKLESS WATER HEATERS. CONNECT 3/4" H&CW TO EACH WATER HEATER. SEE RISER DIAGRAM ON DWG. #MEP-2.0
- 4 2"GAS DROP ON WALL WITH GAS VALVE TO TANKLESS WATER HEATERS. CONNECT 3/4" GAS TO EACH WATER HEATER. SEE RISER DIAGRAM ON DWG. #MEP-2.0
- 5 2"GAS DROP ON WALL WITH GAS VALVE TO EACH BOILER. (999 MBH INPUT EACH)
- 6 1"COLD WATER MAKE-UP ON WALL TO BACKFLOW PREVENTER RPZ FOR HVAC SYSTEM. COORDINATE LOCATION IN THE FIELD. SEE INSTALLATION DETAIL ON DWG. #MEP-2.0
- 7 EXPANSION TANK MOUNTED INLINE ON COLD WATER LINE.
- 8 CONNECT NEW COLD WATER MAKE-UP TO EXISTING IN THIS AREA. COORDINATE LOCATION IN THE FIELD.
- 9 CONNECT NEW 2"GAS TO GAS METER ASSEMBLY AND EXTEND TO NEW BOILER AND WATER HEATERS. CORE DRILL BRICK/BLOCK WALL FOR NEW GAS LINE. PATCH AND REPAIR SURFACES TO MATCH EXISTING.
- 10 WATER HEATER EMERGENCY SHUT-OFF SWITCHES. EACH SHALL BE PROPERLY IDENTIFIED WITH LABEL OF EQUIPMENT IT SERVES.
- 11 INTERFACE WITH WATER HEATER CONTROLS TO TURN-OFF POWER TO CONTROLS.
- 12 NEW PANEL COORDINATE EXACT LOCATION WITH ATC PANEL IN FIELD. REFER TO MEP DETAILS AND SCHEDULES FOR ADDITIONAL INFORMATION.
- 13 NEW 1 1/2"GAS TO GAS WITH GAS VALVE CAPPED FOR FUTURE USE.
- 14 RINNAI CONCENTRIC VENT SYSTEM SHALL INCLUDE: ROOF DISCHARGE TERMINATION, FLASHING ASSEMBLY, VENT PIPE, CONDENSATE TRAP, VENT PIPE, EXTENSIONS AND FITTINGS AS REQUIRED. TERMINATE 38" ABOVE ROOF.


**NOTE:**  
REFER TO MEP DRAWINGS  
FOR ADDITIONAL INFORMATION.

MILITARY PROJECT #11MIL217-2401

 <b>BVH</b> integrates services <small>CIVIL, STRUCTURAL, MECHANICAL, ELECTRICAL, COMMISSIONING AND TECHNOLOGY</small>	<b>ENFIELD ARMORY - PLUMBING BOILER ROOM PART PLANS</b>		<b>STATE OF CONNECTICUT</b> DEPARTMENT OF PUBLIC WORKS	
	drawing title <b>ENFIELD ARMORY - PLUMBING BOILER ROOM PART PLANS</b>		date 02/28/2011	
<b>REVISIONS</b>				
mark	date	description		
drawings prepared by BVH INTEGRATED SERVICES 50 GRIFFIN ROAD SOUTH, BLOOMFIELD, CT 06002			scale 1/4"=1'-0"	
project BOILER & HOT WATER HEATER UPGRADES ENFIELD & NORWALK ARMORIES ENFIELD & NORWALK, CT			drawn by CCK	
CAD no.			approved by CVD	
project no.			drawing no. <b>P-1.0</b>	
21-10-155			project no.	
SEAL			81-Q-644	

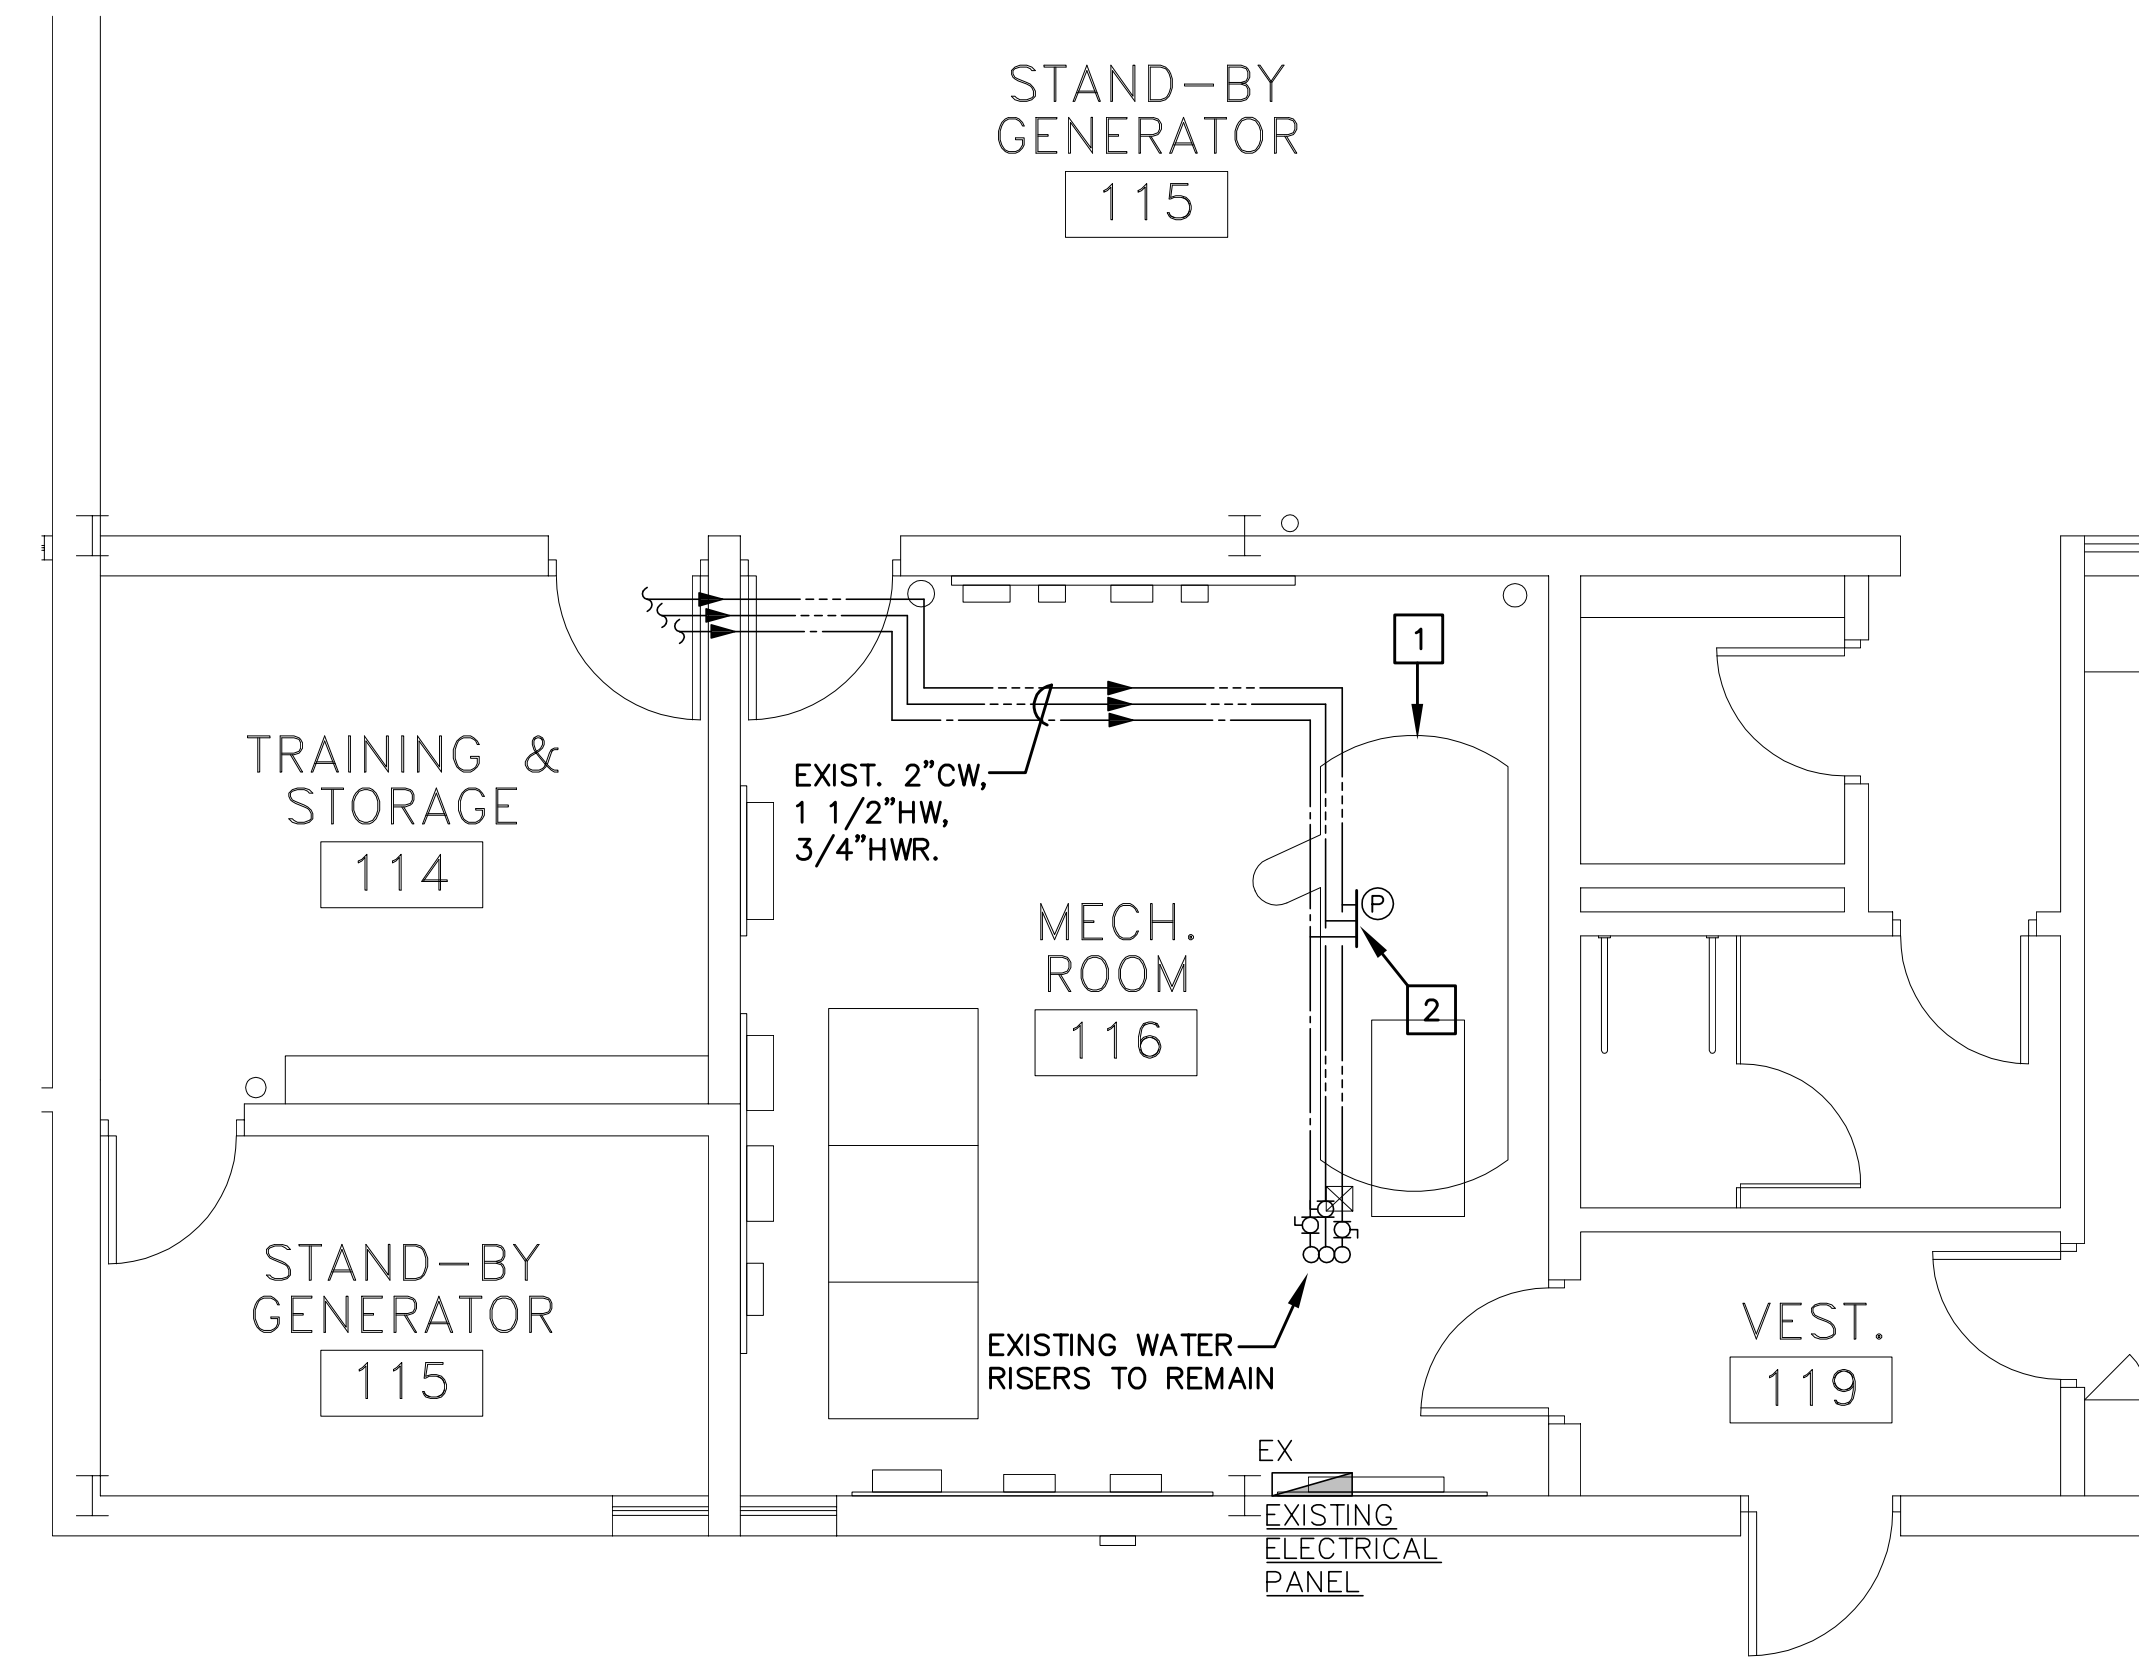

**NORWALK ARMORY - PLUMBING DEMOLITION BOILER ROOM PART PLAN**  
SCALE: 1/4"=1'-0"

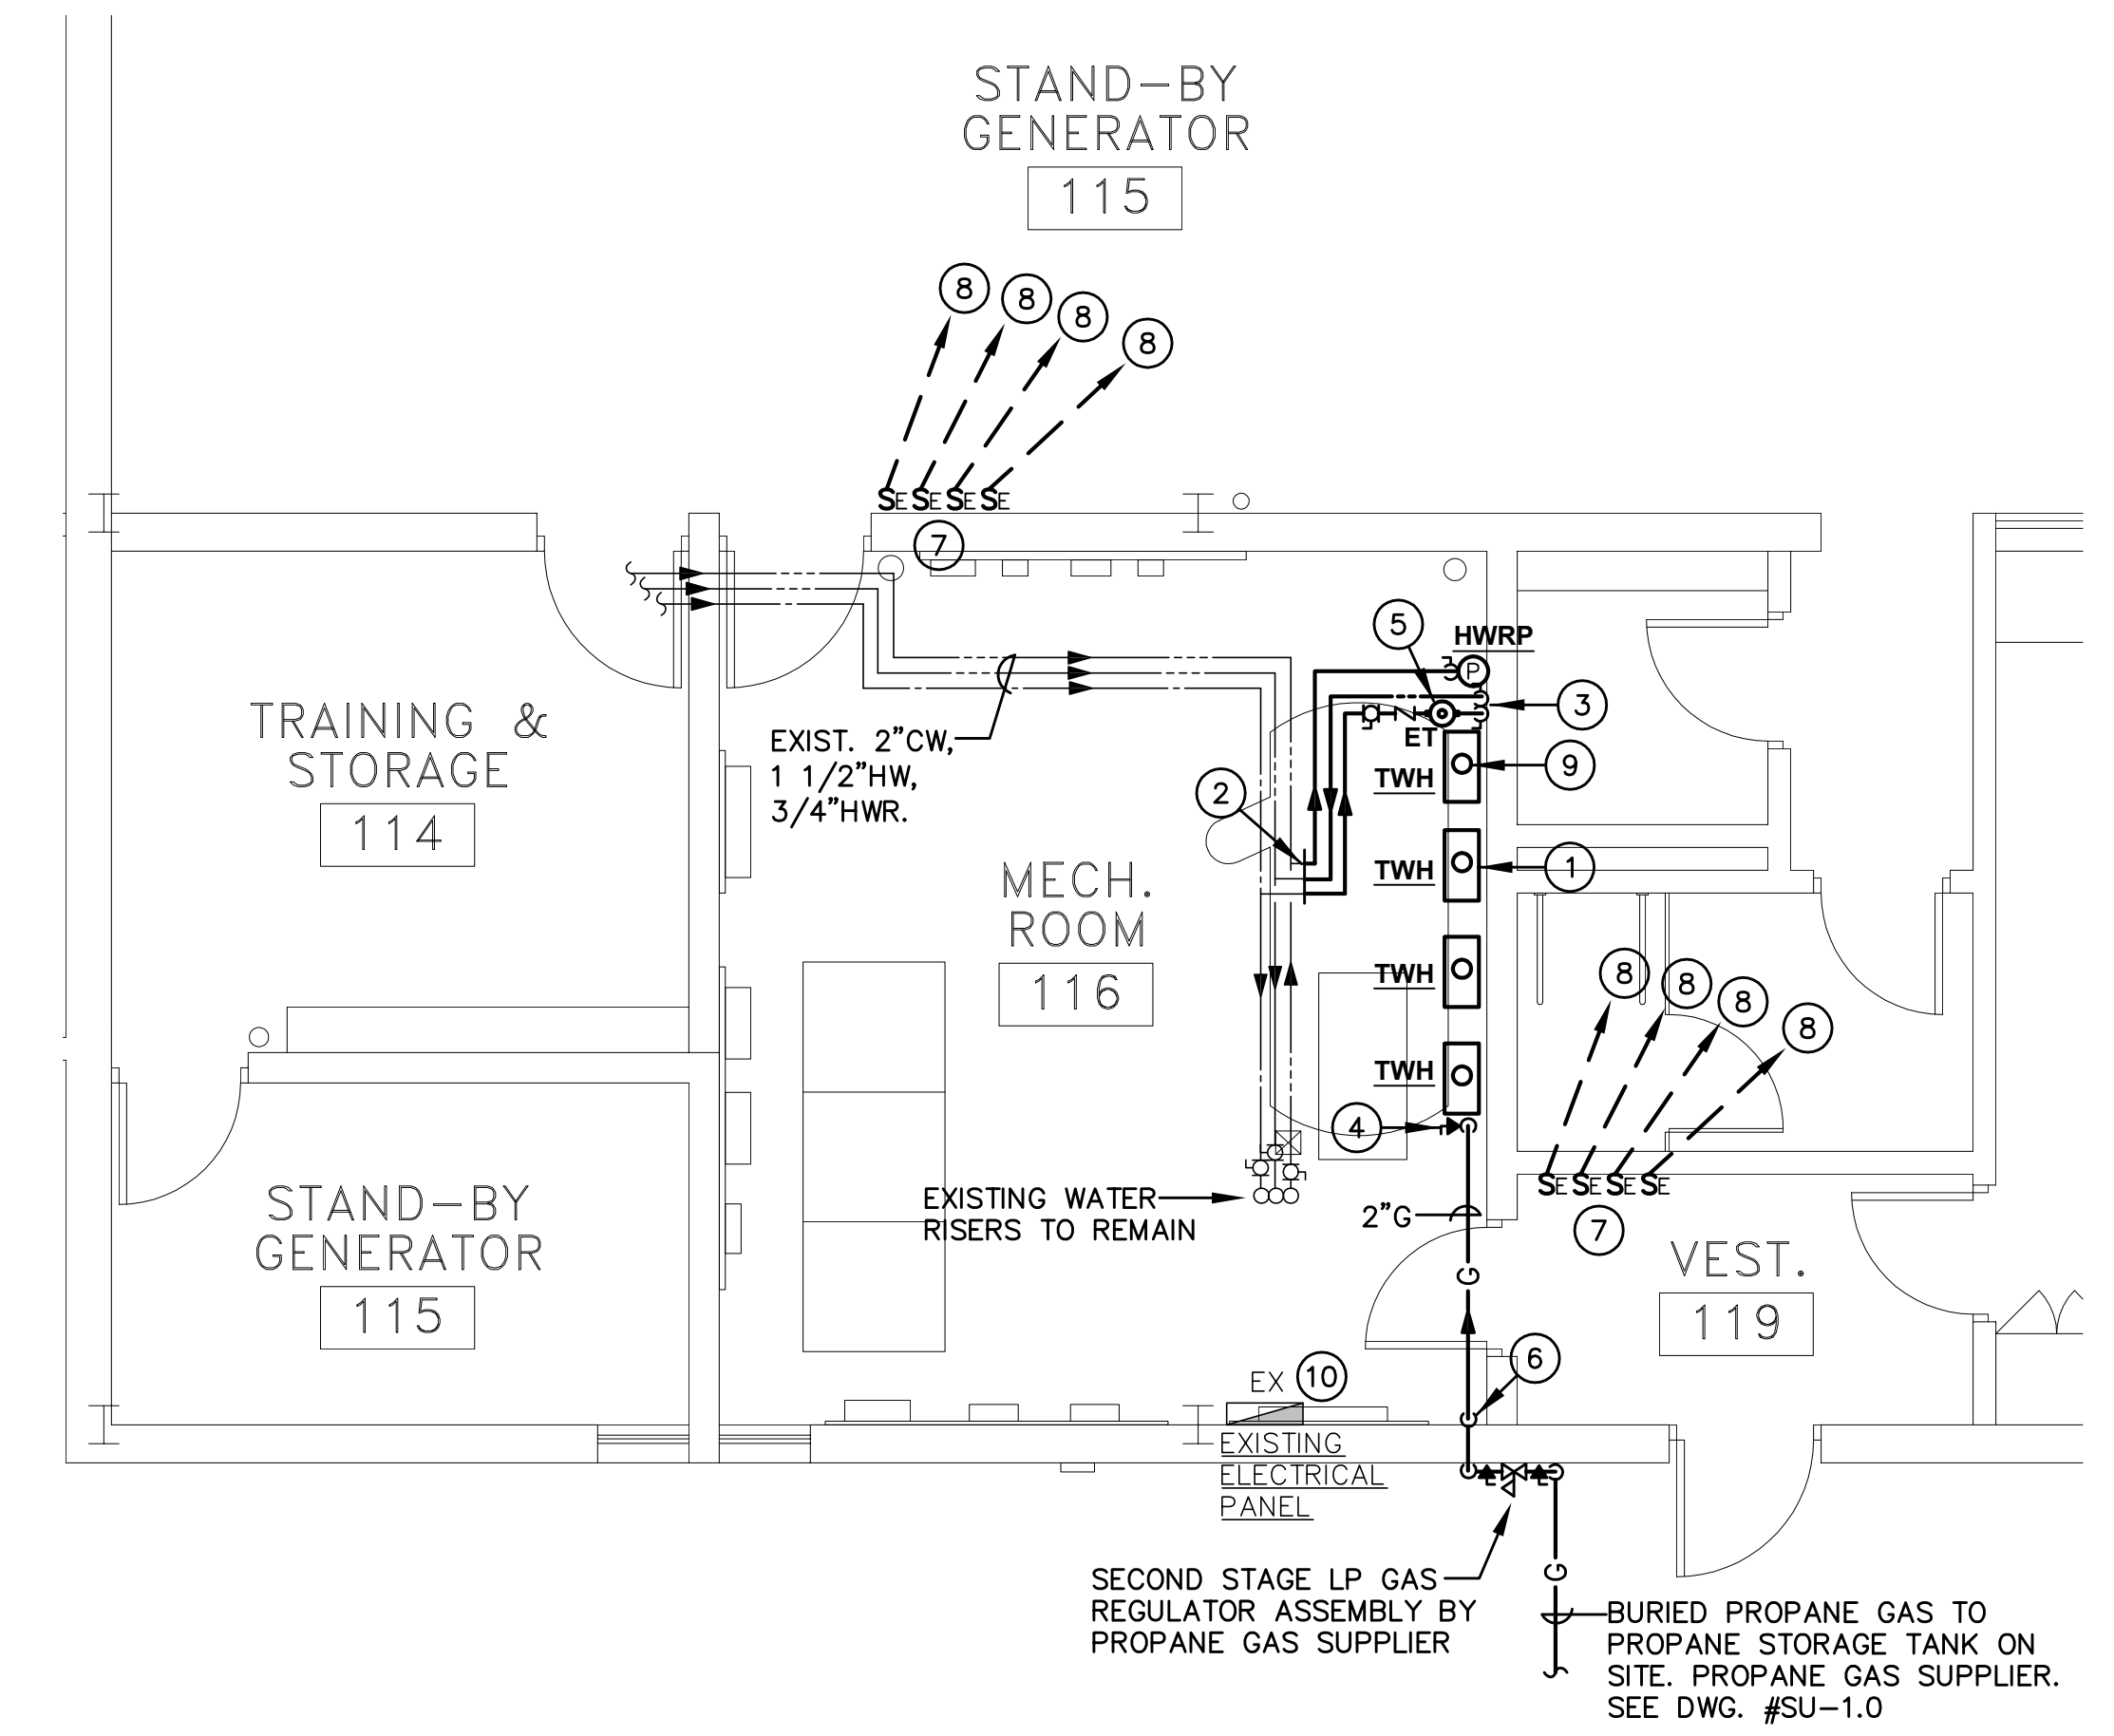

**NORWALK ARMORY - PLUMBING BOILER ROOM PART PLAN**  
SCALE: 1/4"=1'-0"

**DEMOLITION NOTES**



- 1 REMOVE EXISTING ELECTRIC STORAGE TYPE WATER HEATER AND ASSOCIATED PUMP, PIPING AND CONTROLS.
- 2 REMOVE EXISTING 1 1/2"H&CW, 3/4"HWR UP TO THIS POINT.

**DRAWING NOTES**


- 1 (4) NEW TANKLESS GAS FIRED (PROPANE) CONDENSING WATER HEATERS MOUNTED ON WALL. SEE RISER DIAGRAM ON DWG. #MEP-2.0 AND WATER HEATER SCHEDULE ON DWG. #MEP-3.0
- 2 CONNECT NEW 1 1/2"H&CW, 3/4"HWR TO EXISTING PIPING AND EXTEND TO NEW WATER HEATERS.
- 3 1 1/2"H&CW, 3/4"HWR DROP ON WALL TO TANKLESS WATER HEATERS. CONNECT 3/4" H&CW TO EACH WATER HEATER. SEE RISER DIAGRAM ON DWG. #MEP-2.0
- 4 2"GAS DROP DROP ON WALL WITH GAS VALVE TO TANKLESS WATER HEATERS. CONNECT 3/4" GAS TO EACH WATER HEATER. SEE RISER DIAGRAM ON DWG. #MEP-2.0
- 5 EXPANSION TANK MOUNTED INLINE ON COLD WATER LINE.
- 6 CONNECT NEW 2"GAS TO GAS REGULATOR ASSEMBLY AND EXTEND TO WATER HEATERS. CORE DRILL BRICK/BLOCK WALL FOR NEW GAS LINE. PATCH AND REPAIR SURFACES TO MATCH EXISTING.
- 7 WATER HEATER EMERGENCY SHUT-OFF SWITCHES. EACH SHALL BE PROPERLY IDENTIFIED WITH LABEL OF EQUIPMENT IT SERVES.
- 8 INTERFACE WITH WATER HEATER CONTROLS TO TURN-OFF POWER TO CONTROLS.
- 9 RINNAI CONCENTRIC VENT SYSTEM SHALL INCLUDE: ROOF DISCHARGE TERMINATION, FLASHING ASSEMBLY, VENT PIPE, CONDENSATE TRAP, VENT PIPE, EXTENSIONS AND FITTINGS AS REQUIRED. TERMINATE 36" ABOVE ROOF.
- 10 FURNISH AND INSTALL TWO (2) 20A-1P CIRCUIT BREAKERS TO FEED NEW MECHANICAL EQUIPMENT. NEW CIRCUIT BREAKERS SHALL BE COMPATIBLE WITH EXISTING PANEL.

**NOTE:**  
REFER TO MEP DRAWINGS  
FOR ADDITIONAL INFORMATION.


MILITARY PROJECT #11MIL217-2401

 <b>BVH</b> integrates services <small>CIVIL, STRUCTURAL, MECHANICAL, ELECTRICAL, COMMISSIONING AND TECHNOLOGY</small>	<b>NORWALK ARMORY - PLUMBING BOILER ROOM PART PLANS</b>		<b>STATE OF CONNECTICUT</b> DEPARTMENT OF PUBLIC WORKS						
	<b>REVISIONS</b>		drawings prepared by BVH INTEGRATED SERVICES 50 GRIFFIN ROAD SOUTH, BLOOMFIELD, CT 06002						
<table border="1"> <thead> <tr> <th>mark</th> <th>date</th> <th>description</th> </tr> </thead> <tbody> <tr> <td> </td> <td> </td> <td> </td> </tr> </tbody> </table>		mark	date	description				date: 02/28/2011 scale: 1/4"=1'-0" drawn by: CCK approved by: CVD drawing no.: P-2.0	
mark	date	description							
		project: BOILER & HOT WATER HEATER UPGRADES ENFIELD & NORWALK ARMORIES ENFIELD & NORWALK, CT							
CAD no.:		project no.: 81-Q-644							



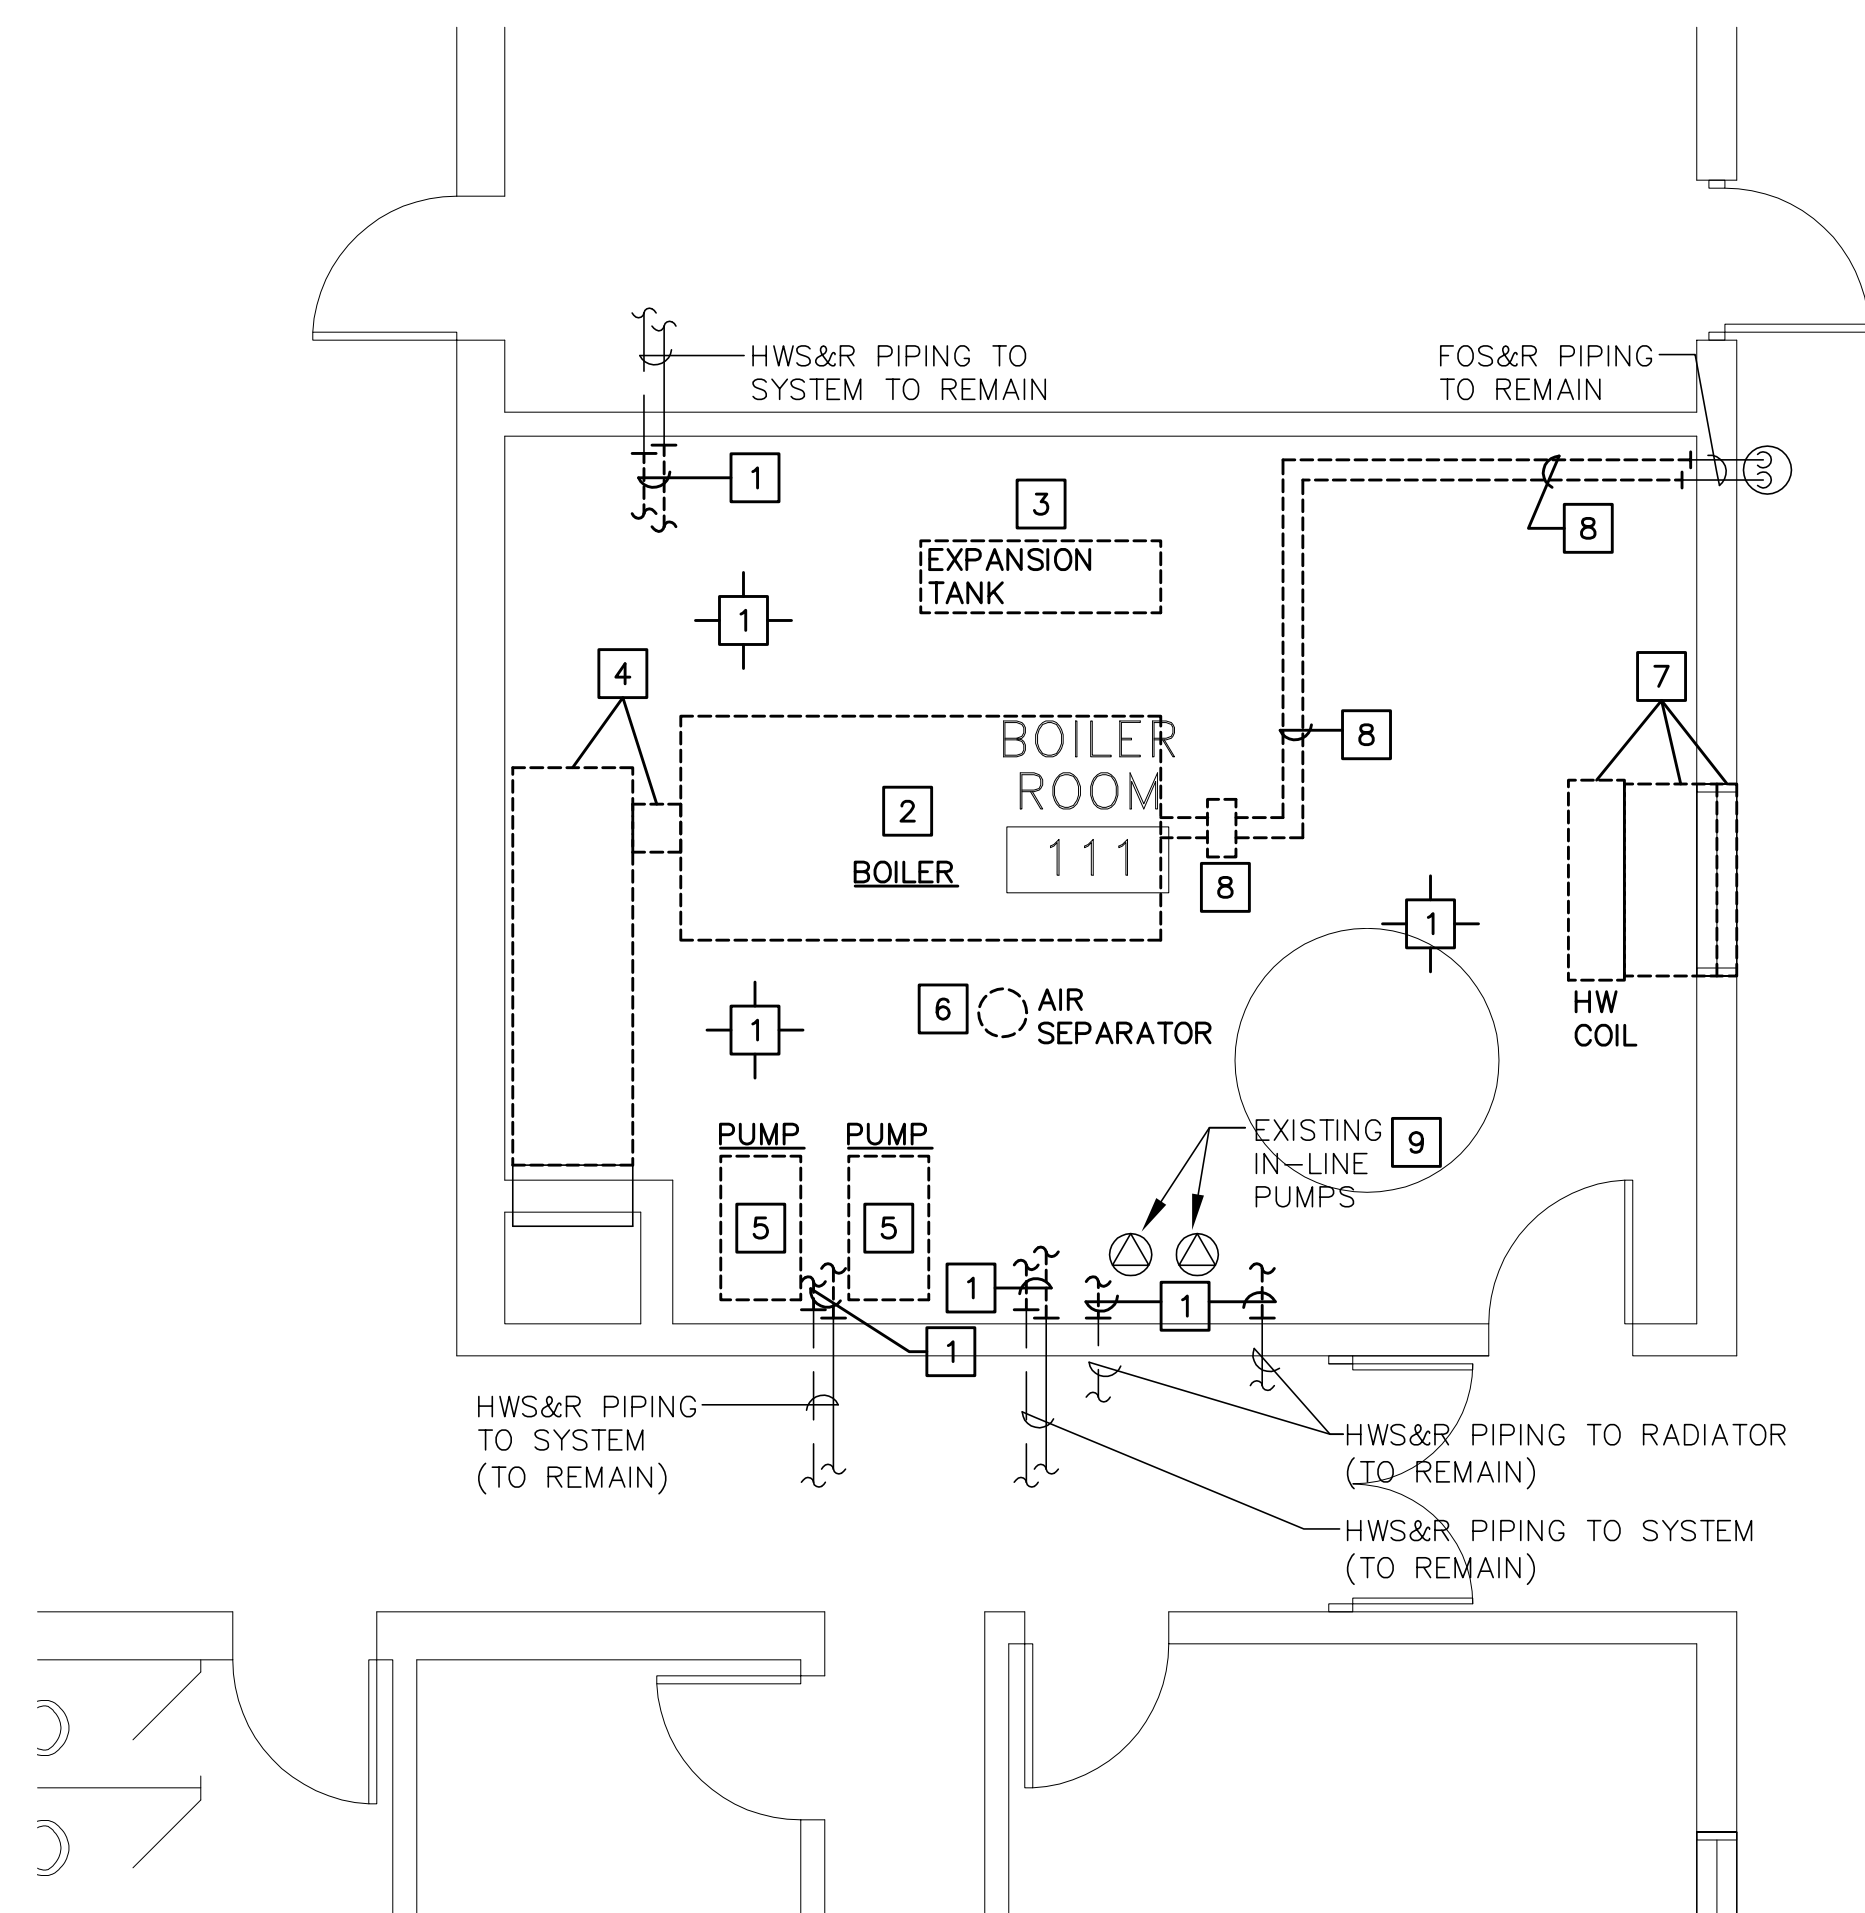

**ENFIELD ARMORY - HVAC DEMOLITION BOILER ROOM PART PLAN**  
SCALE: 1/4"=1'-0"

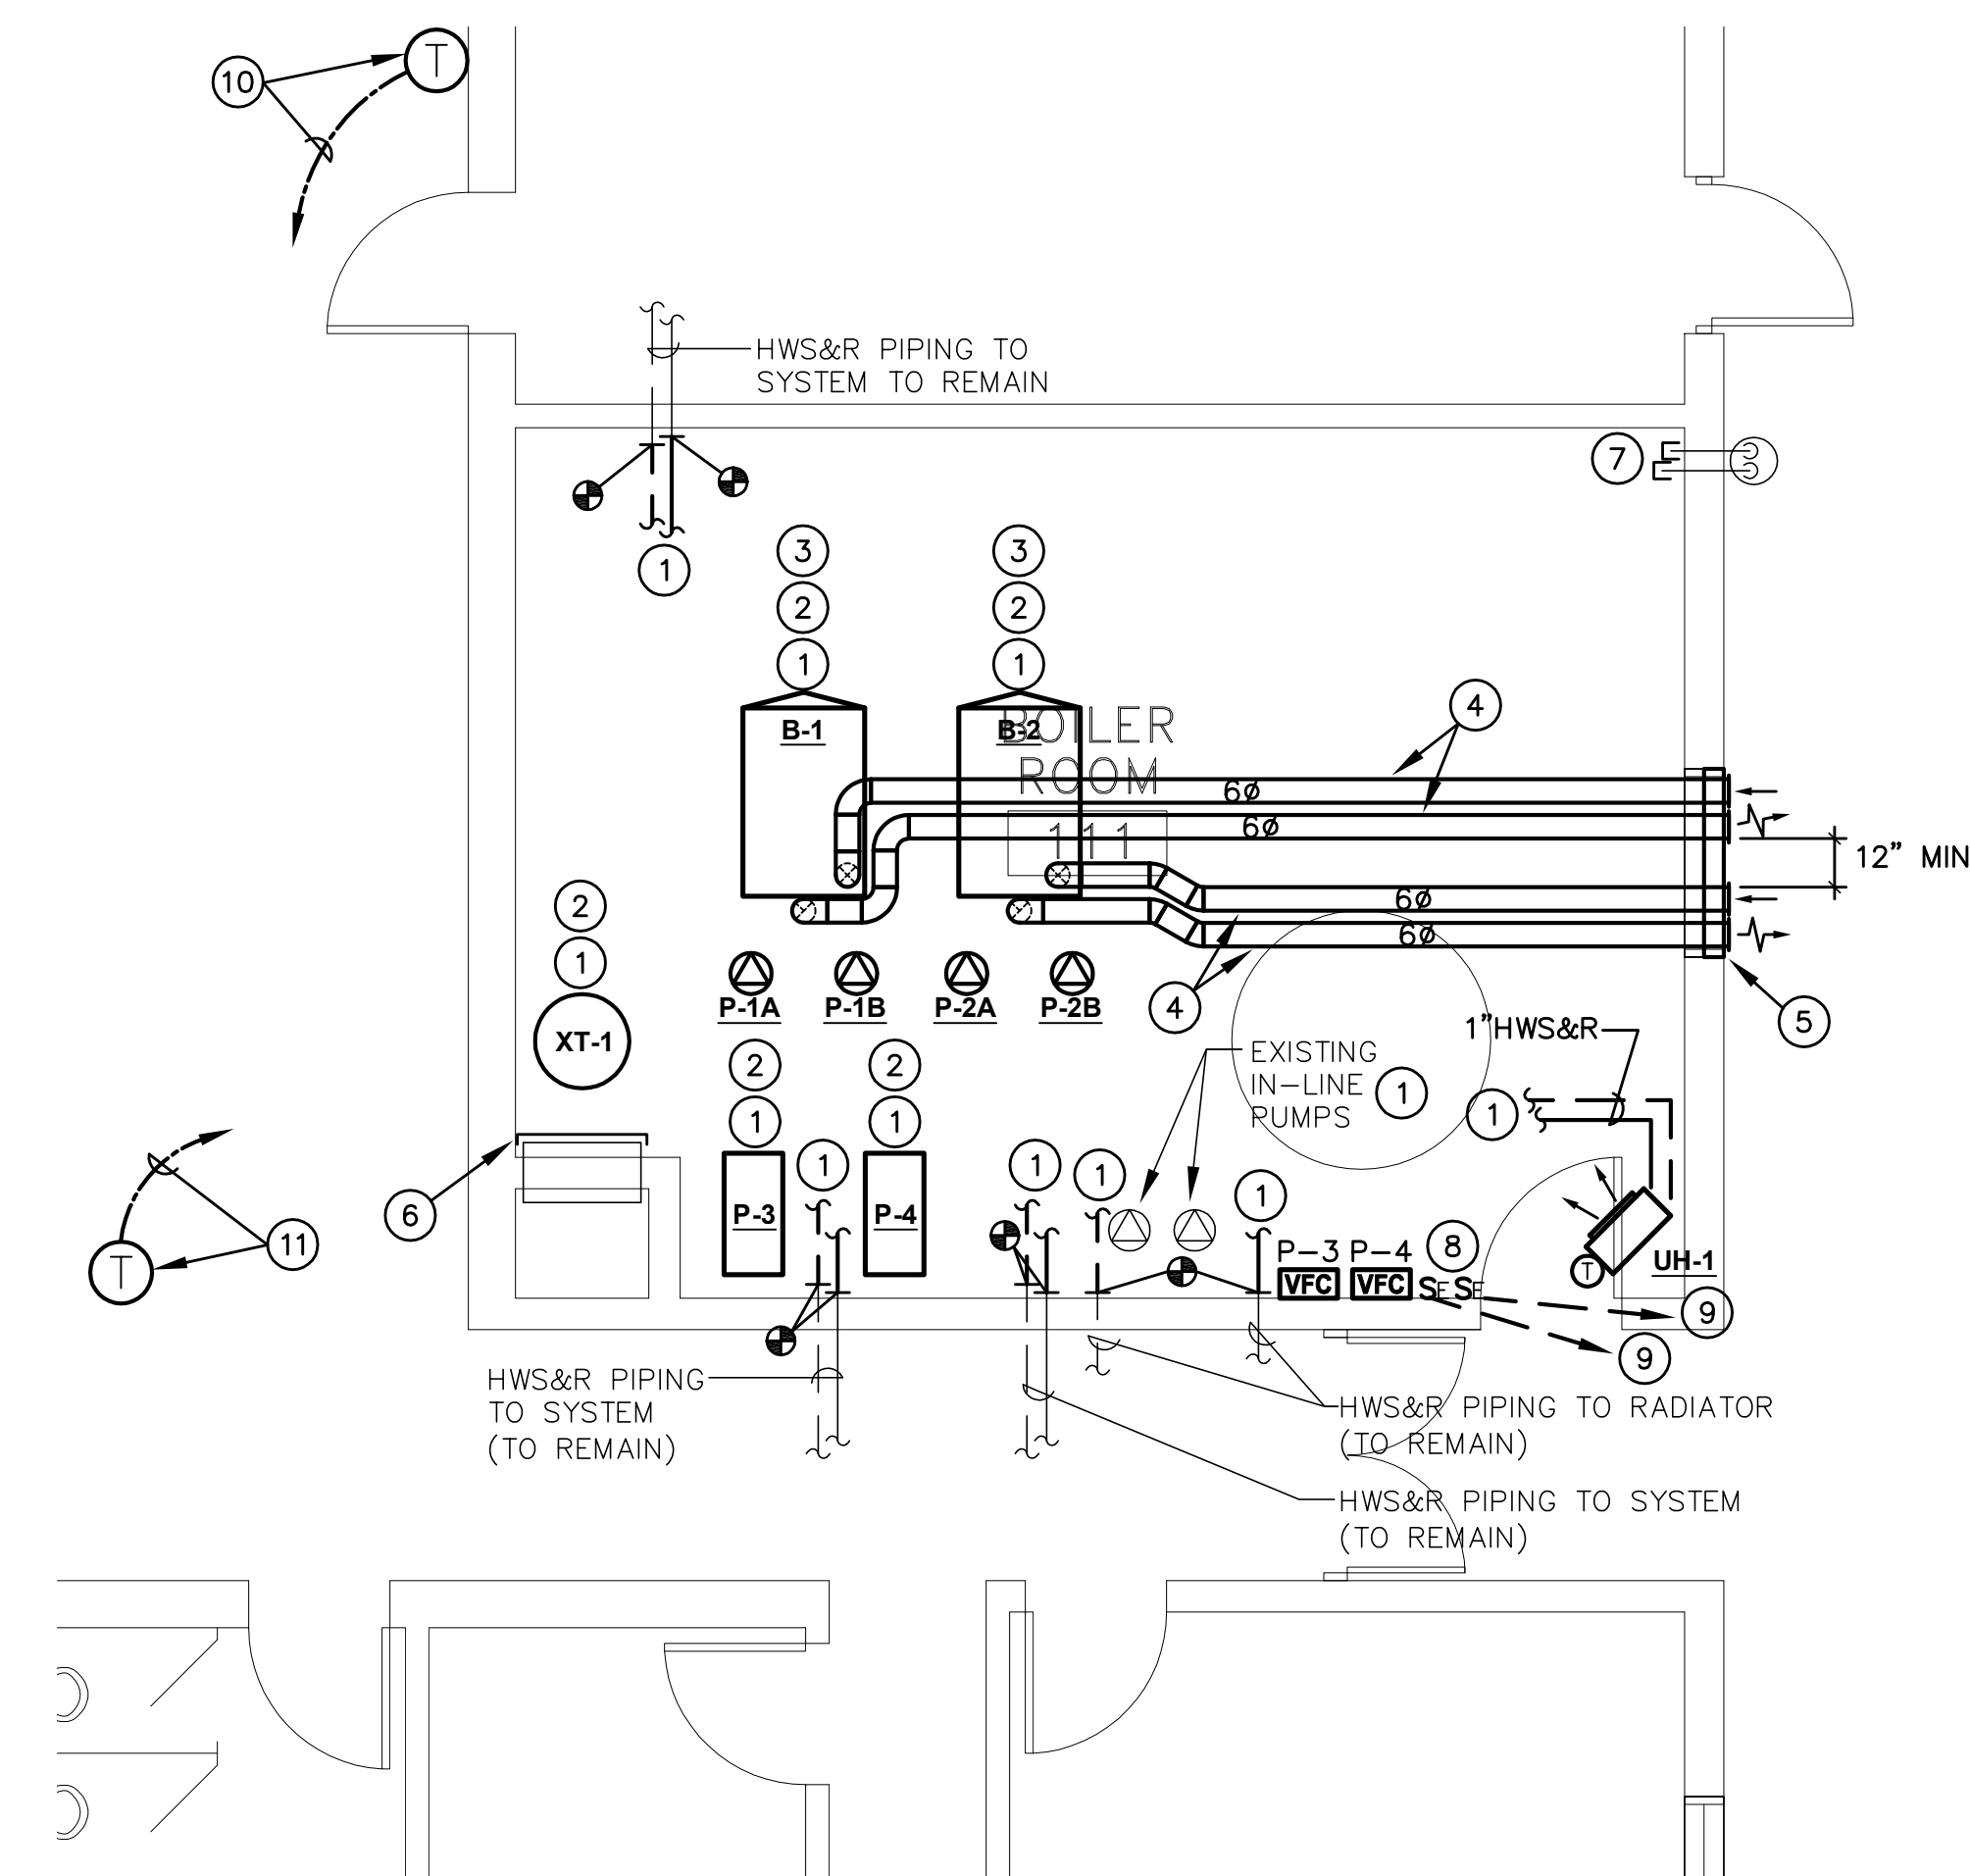

**ENFIELD ARMORY - HVAC BOILER ROOM PART PLAN**  
SCALE: 1/4"=1'-0"

**DEMOLITION NOTES**


- 1 REMOVE HWS&R PIPING AND VALVING TO LIMITS SHOWN. SEE DWG. #H-2.0 FOR SCHEMATIC DEMOLITION HOT WATER FLOW DIAGRAM.
- 2 REMOVE BOILER, PIPING, BRICK BASE AND ASSOCIATED CONTROLS.
- 3 REMOVE EXPANSION TANK AND PIPING.
- 4 REMOVE BOILER BREECHING TO LIMITS SHOWN.
- 5 REMOVE BASE MOUNTED PUMPS, PIPING, CONCRETE BASE AND ASSOCIATED CONTROLS.
- 6 REMOVE AIR SEPARATOR AND PIPING.
- 7 REMOVE COMBUSTION AIR LOUVER, DUCTWORK, HW COIL, PIPING, DAMPER AND ASSOCIATED CONTROLS.
- 8 REMOVE OIL BURNER, FOS&R PIPING AND VALVING TO LIMITS SHOWN.
- 9 REMOVE IN-LINE PUMPS AND RETAIN FOR RE-USE.

**DRAWING NOTES**

- 1 SEE DWG. #H-2.0 FOR SCHEMATIC PRIMARY/SECONDARY HOT WATER FLOW DIAGRAM FOR CONTINUATION OF PIPING.
- 2 PROVIDE 6" HIGH CONCRETE HOUSE KEEPING PAD, 6" LARGER THAN EQUIPMENT ON ALL SIDES.
- 3 PIPE CONDENSATE FROM NEUTRALIZATION KIT INDIRECT TO EXISTING FLOOR DRAIN.
- 4 6"Ø CPVC AIR INTAKE AND FLUE PIPE. TERMINATE AT SIDEWALL WITH VENT TERMINATION PLATE AND VENT TERMINATION CAP. TERMINATE A MINIMUM OF 7'-0" ABOVE WALKWAY.
- 5 PROVIDE INSULATED SHEETMETAL PANEL AT WALL OPENING.
- 6 CAP BOILING BREECHING AT CHIMNEY.
- 7 CAP FUEL OIL PIPING AT WALL PENETRATION.
- 8 BOILER EMERGENCY SHUT-OFF SWITCHES. EACH SWITCH SHALL BE PROPERLY IDENTIFIED WITH LABEL OF EQUIPMENT IT SERVES.
- 9 INTERFACE WITH BOILER CONTROLS TO TURN OFF POWER TO CONTROLS.
- 10 NEW "DDC" SENSOR LOCATED IN DRILL HALL W/WIRE GUARD TO CONTROL PUMPS P-3 & P-4. REFER TO SPECIFICATIONS FOR SEQUENCE OF OPERATIONS.
- 11 NEW "DDC" SENSOR LOCATED IN OFFICE AREA (LOCATION TBD BY ARMORY) TO CONTROL EXISTING IN-LINE PUMPS. REFER TO SPECIFICATIONS FOR SEQUENCE OF OPERATIONS.


**NOTE:**  
REFER TO MEP DRAWINGS  
FOR ADDITIONAL INFORMATION.

MILITARY PROJECT #11MIL217-2401

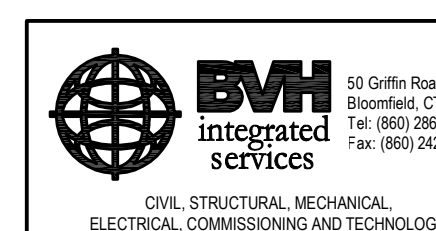

drawing title  
**ENFIELD ARMORY - HVAC  
BOILER ROOM PART PLANS**


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DEPARTMENT OF PUBLIC WORKS

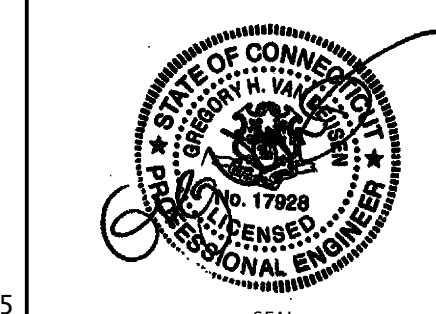


REVISIONS		
mark	date	description

drawings prepared by BVH INTEGRATED SERVICES 50 GRIFFIN ROAD SOUTH, BLOOMFIELD, CT 06002	date 02/28/2011
project BOILER & HOT WATER HEATER UPGRADES ENFIELD & NORWALK ARMORIES ENFIELD & NORWALK, CT	scale 1/4"=1'-0"
approved by CVD	drawn by MEL
CAD no.	project no. 81-Q-644




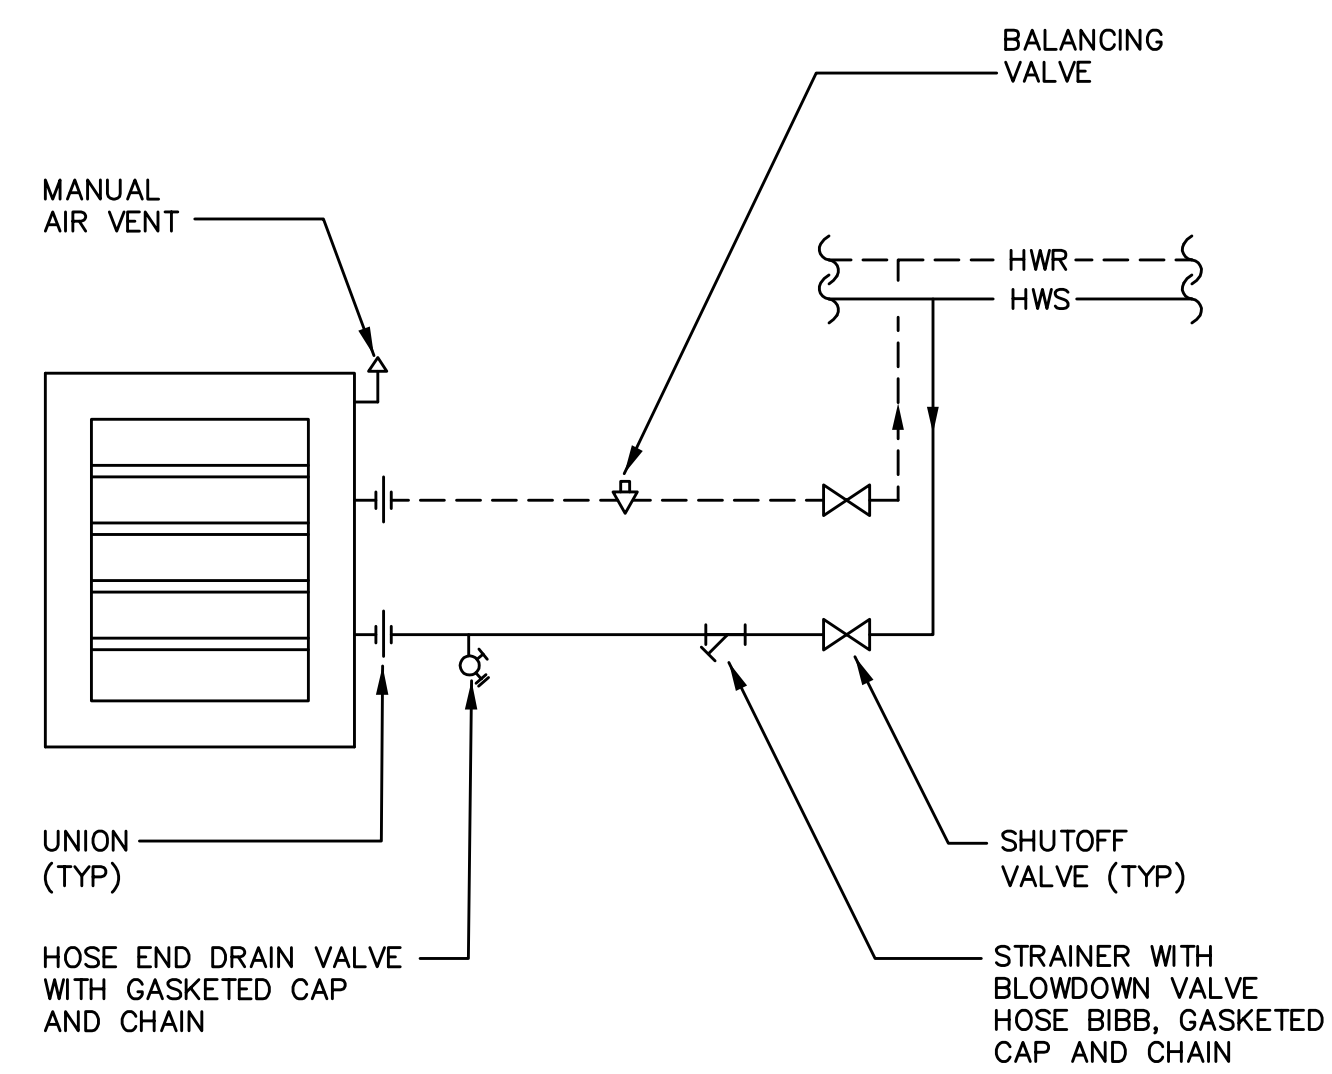

**HOT WATER UNIT HEATER PIPING DETAIL**  
NOT TO SCALE

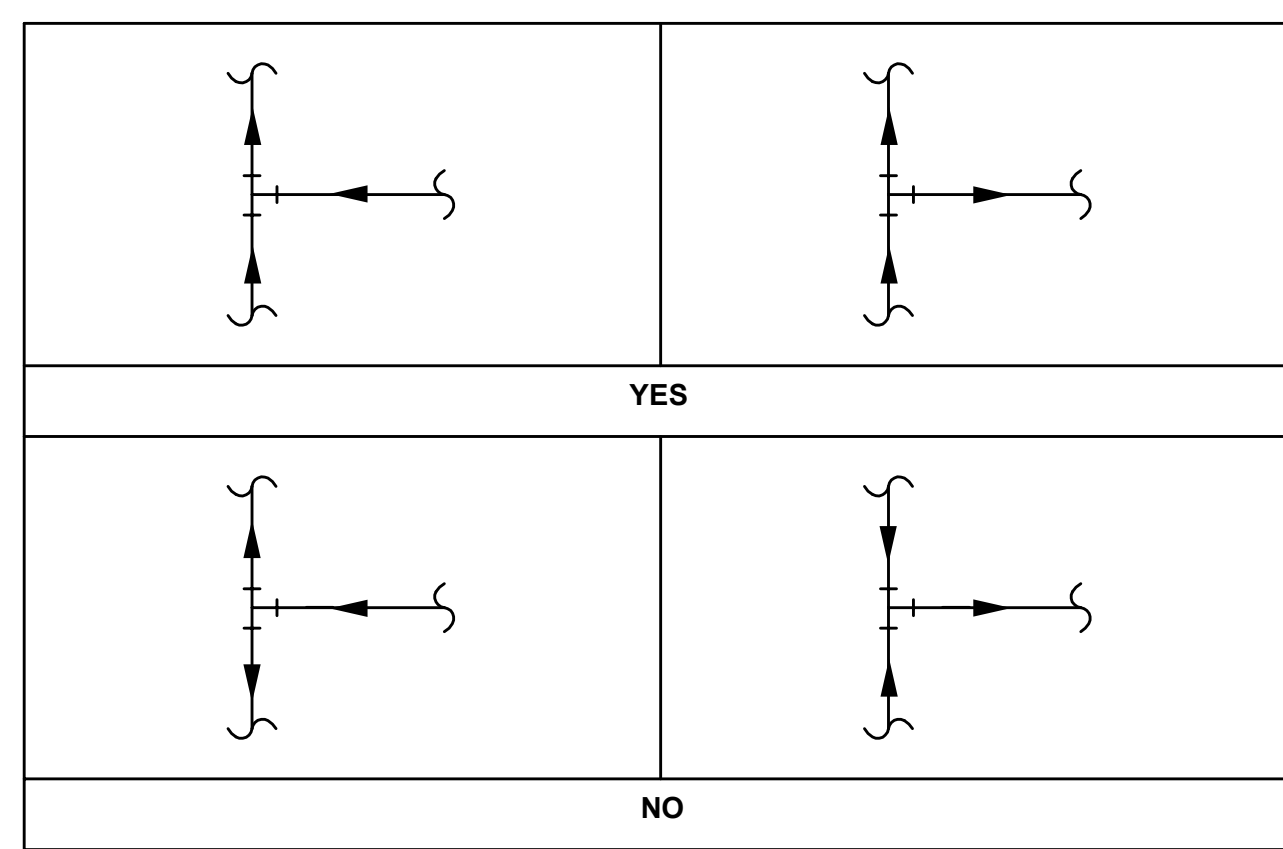


**ALLOWABLE FLOW CONFIGURATIONS IN PIPING TEES - HVAC SYSTEMS**  
NOT TO SCALE

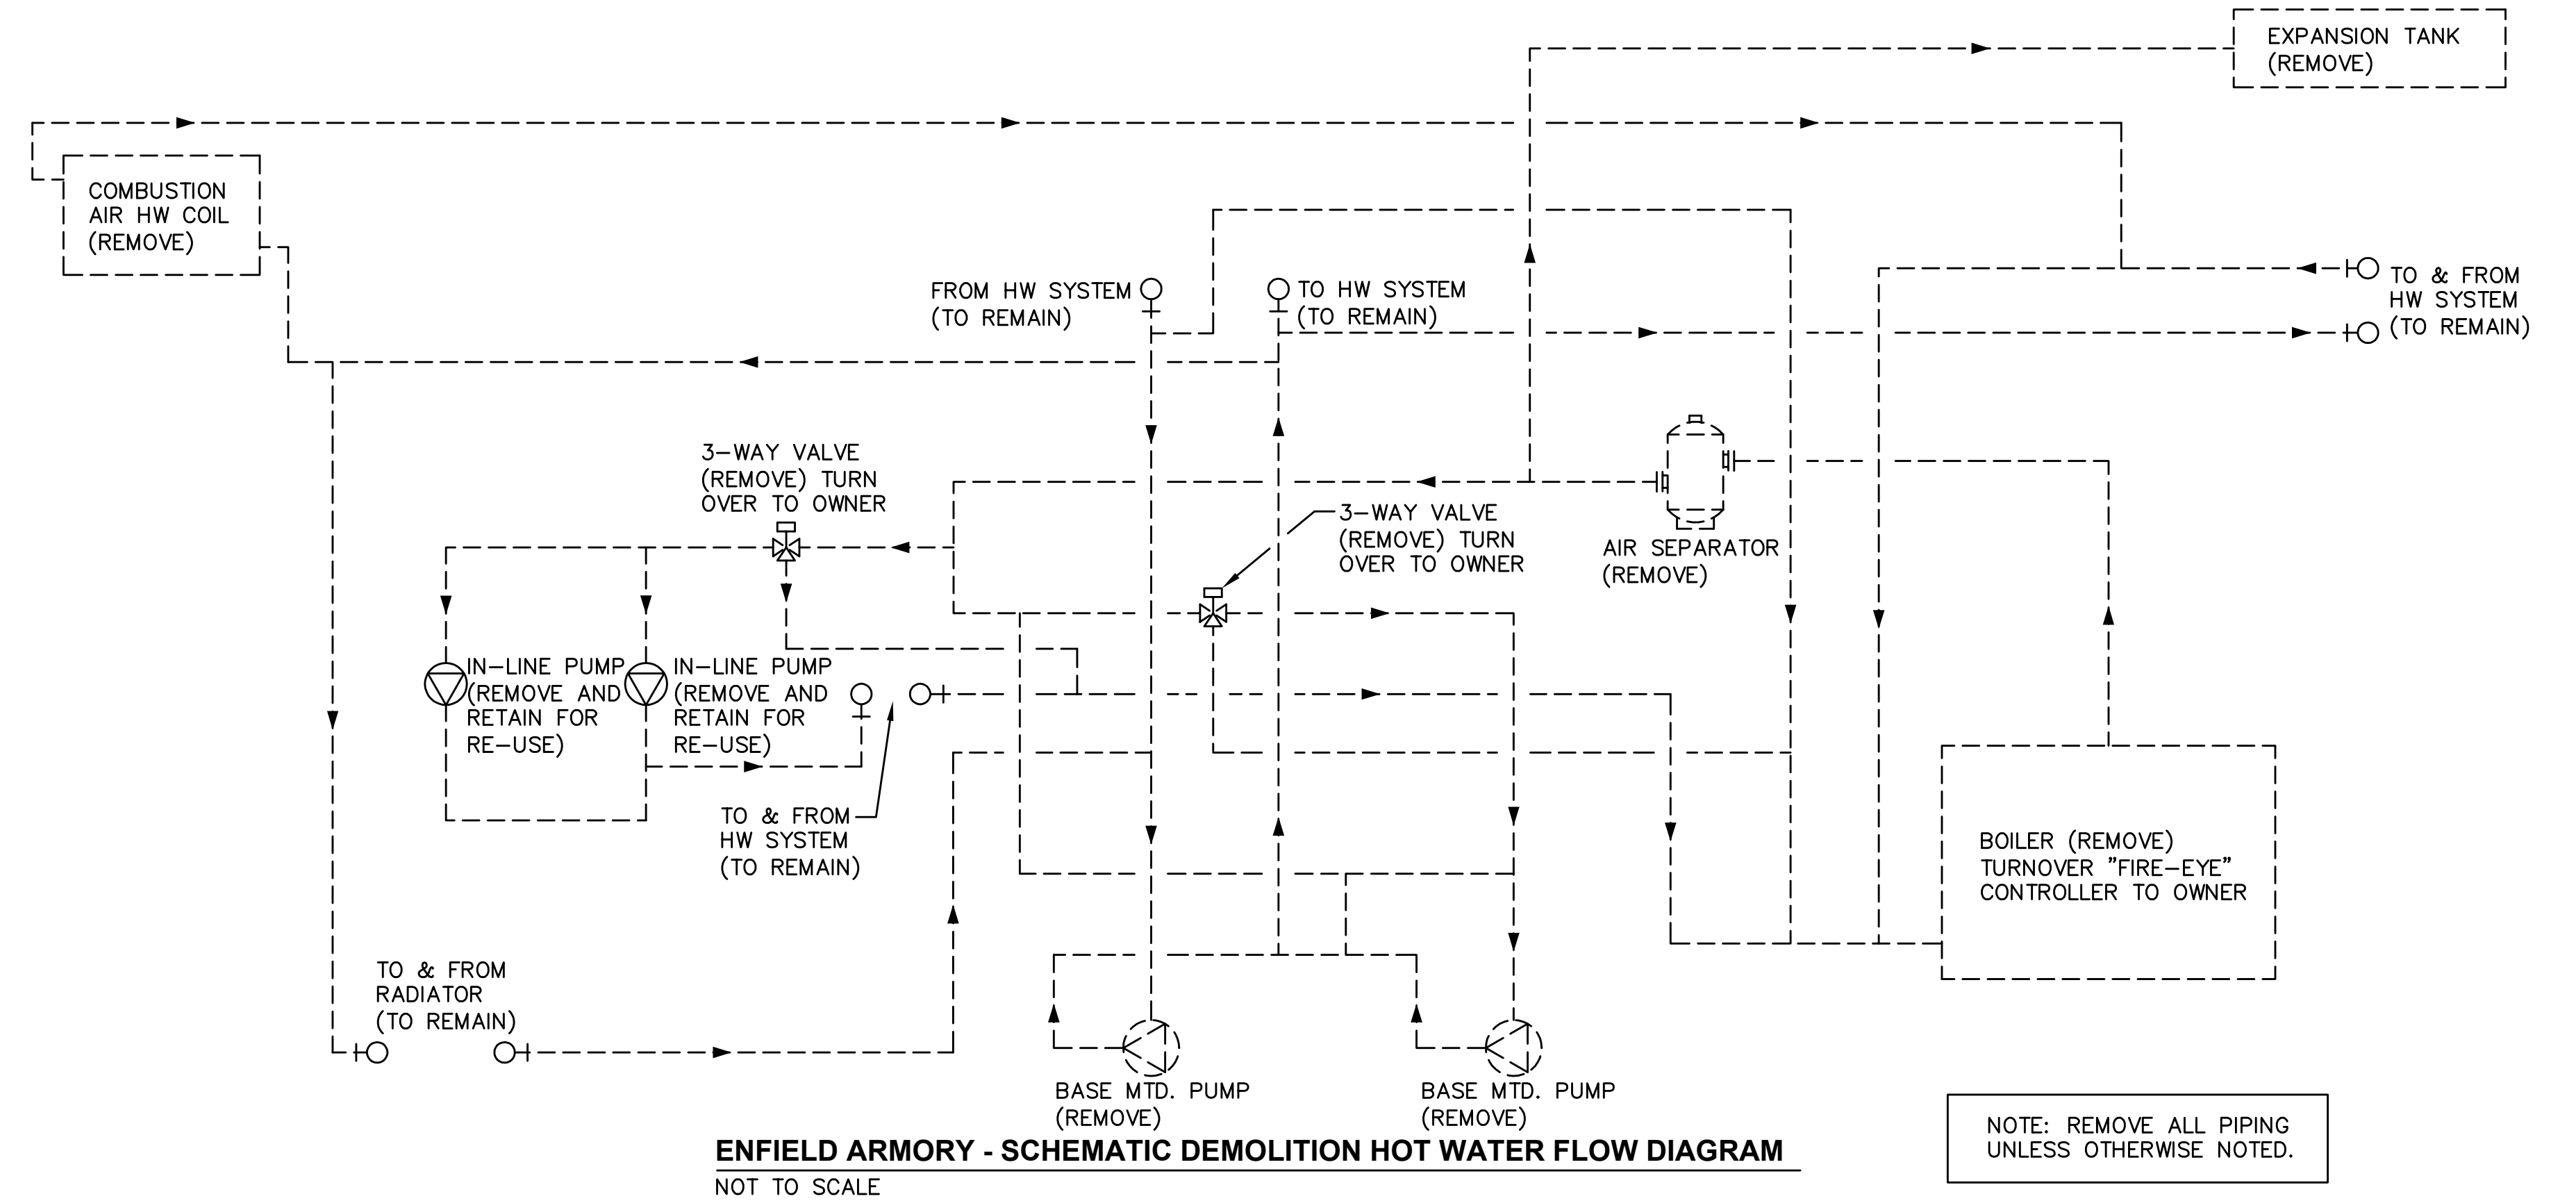


**ENFIELD ARMORY - SCHEMATIC DEMOLITION HOT WATER FLOW DIAGRAM**  
NOT TO SCALE


NOTE: REMOVE ALL PIPING UNLESS OTHERWISE NOTED.

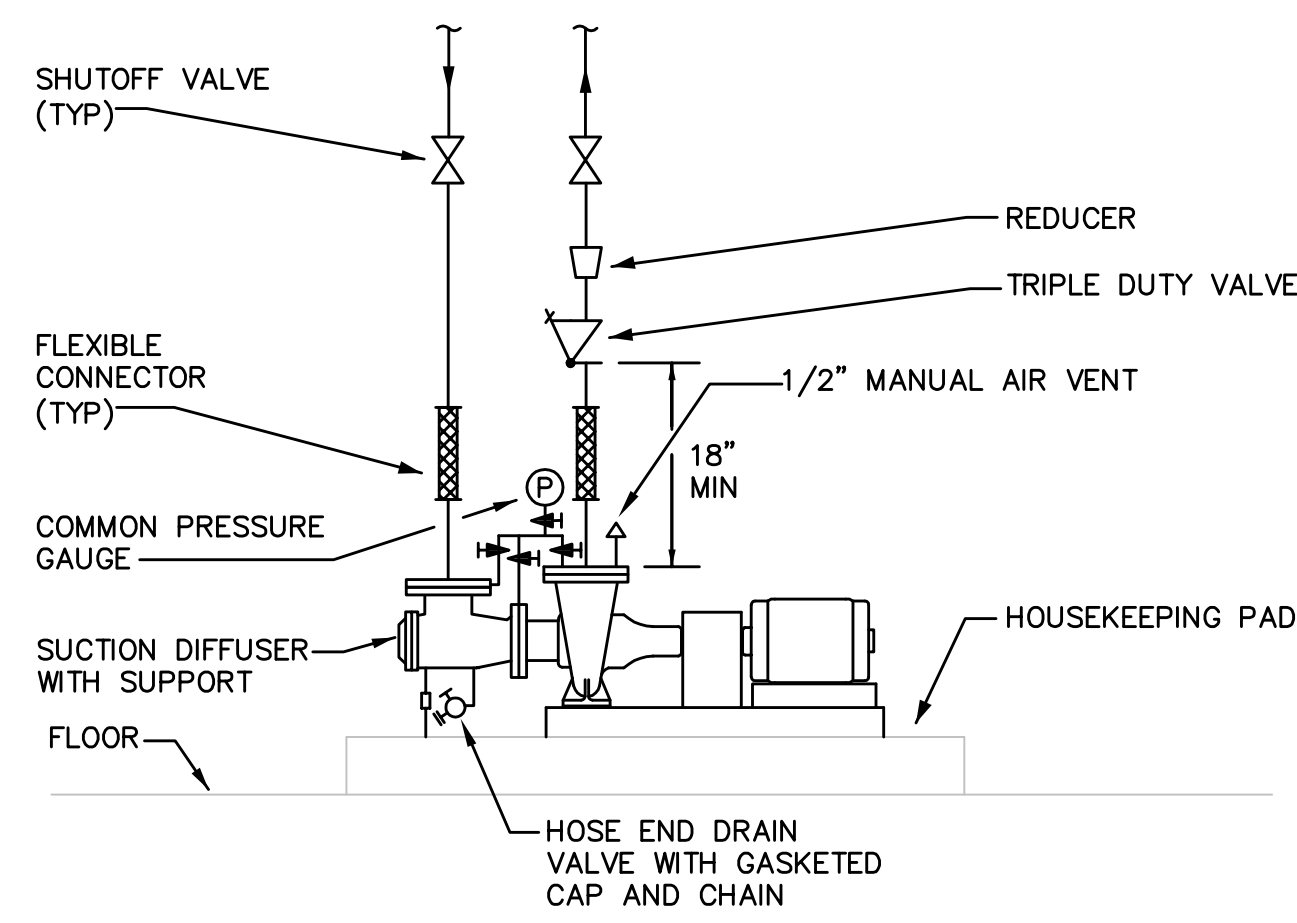


**BASE MOUNTED PUMP DETAIL**  
NOT TO SCALE

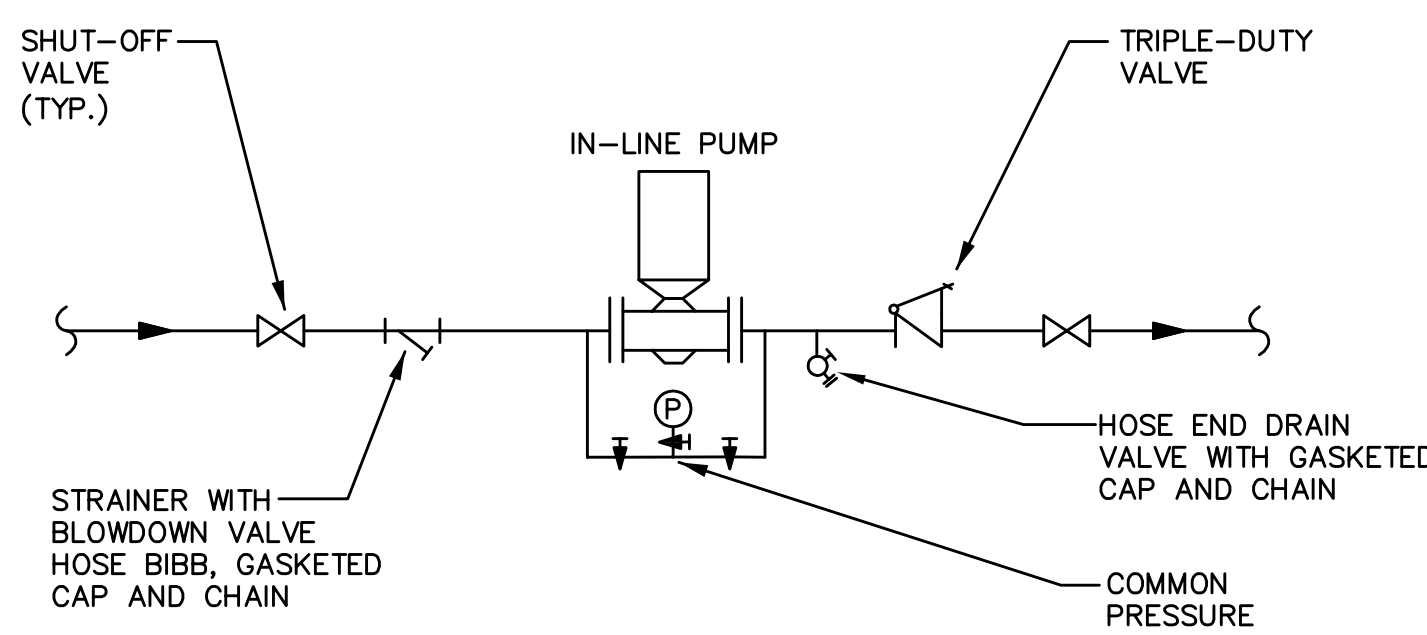


**IN-LINE PUMP DETAIL**  
NOT TO SCALE

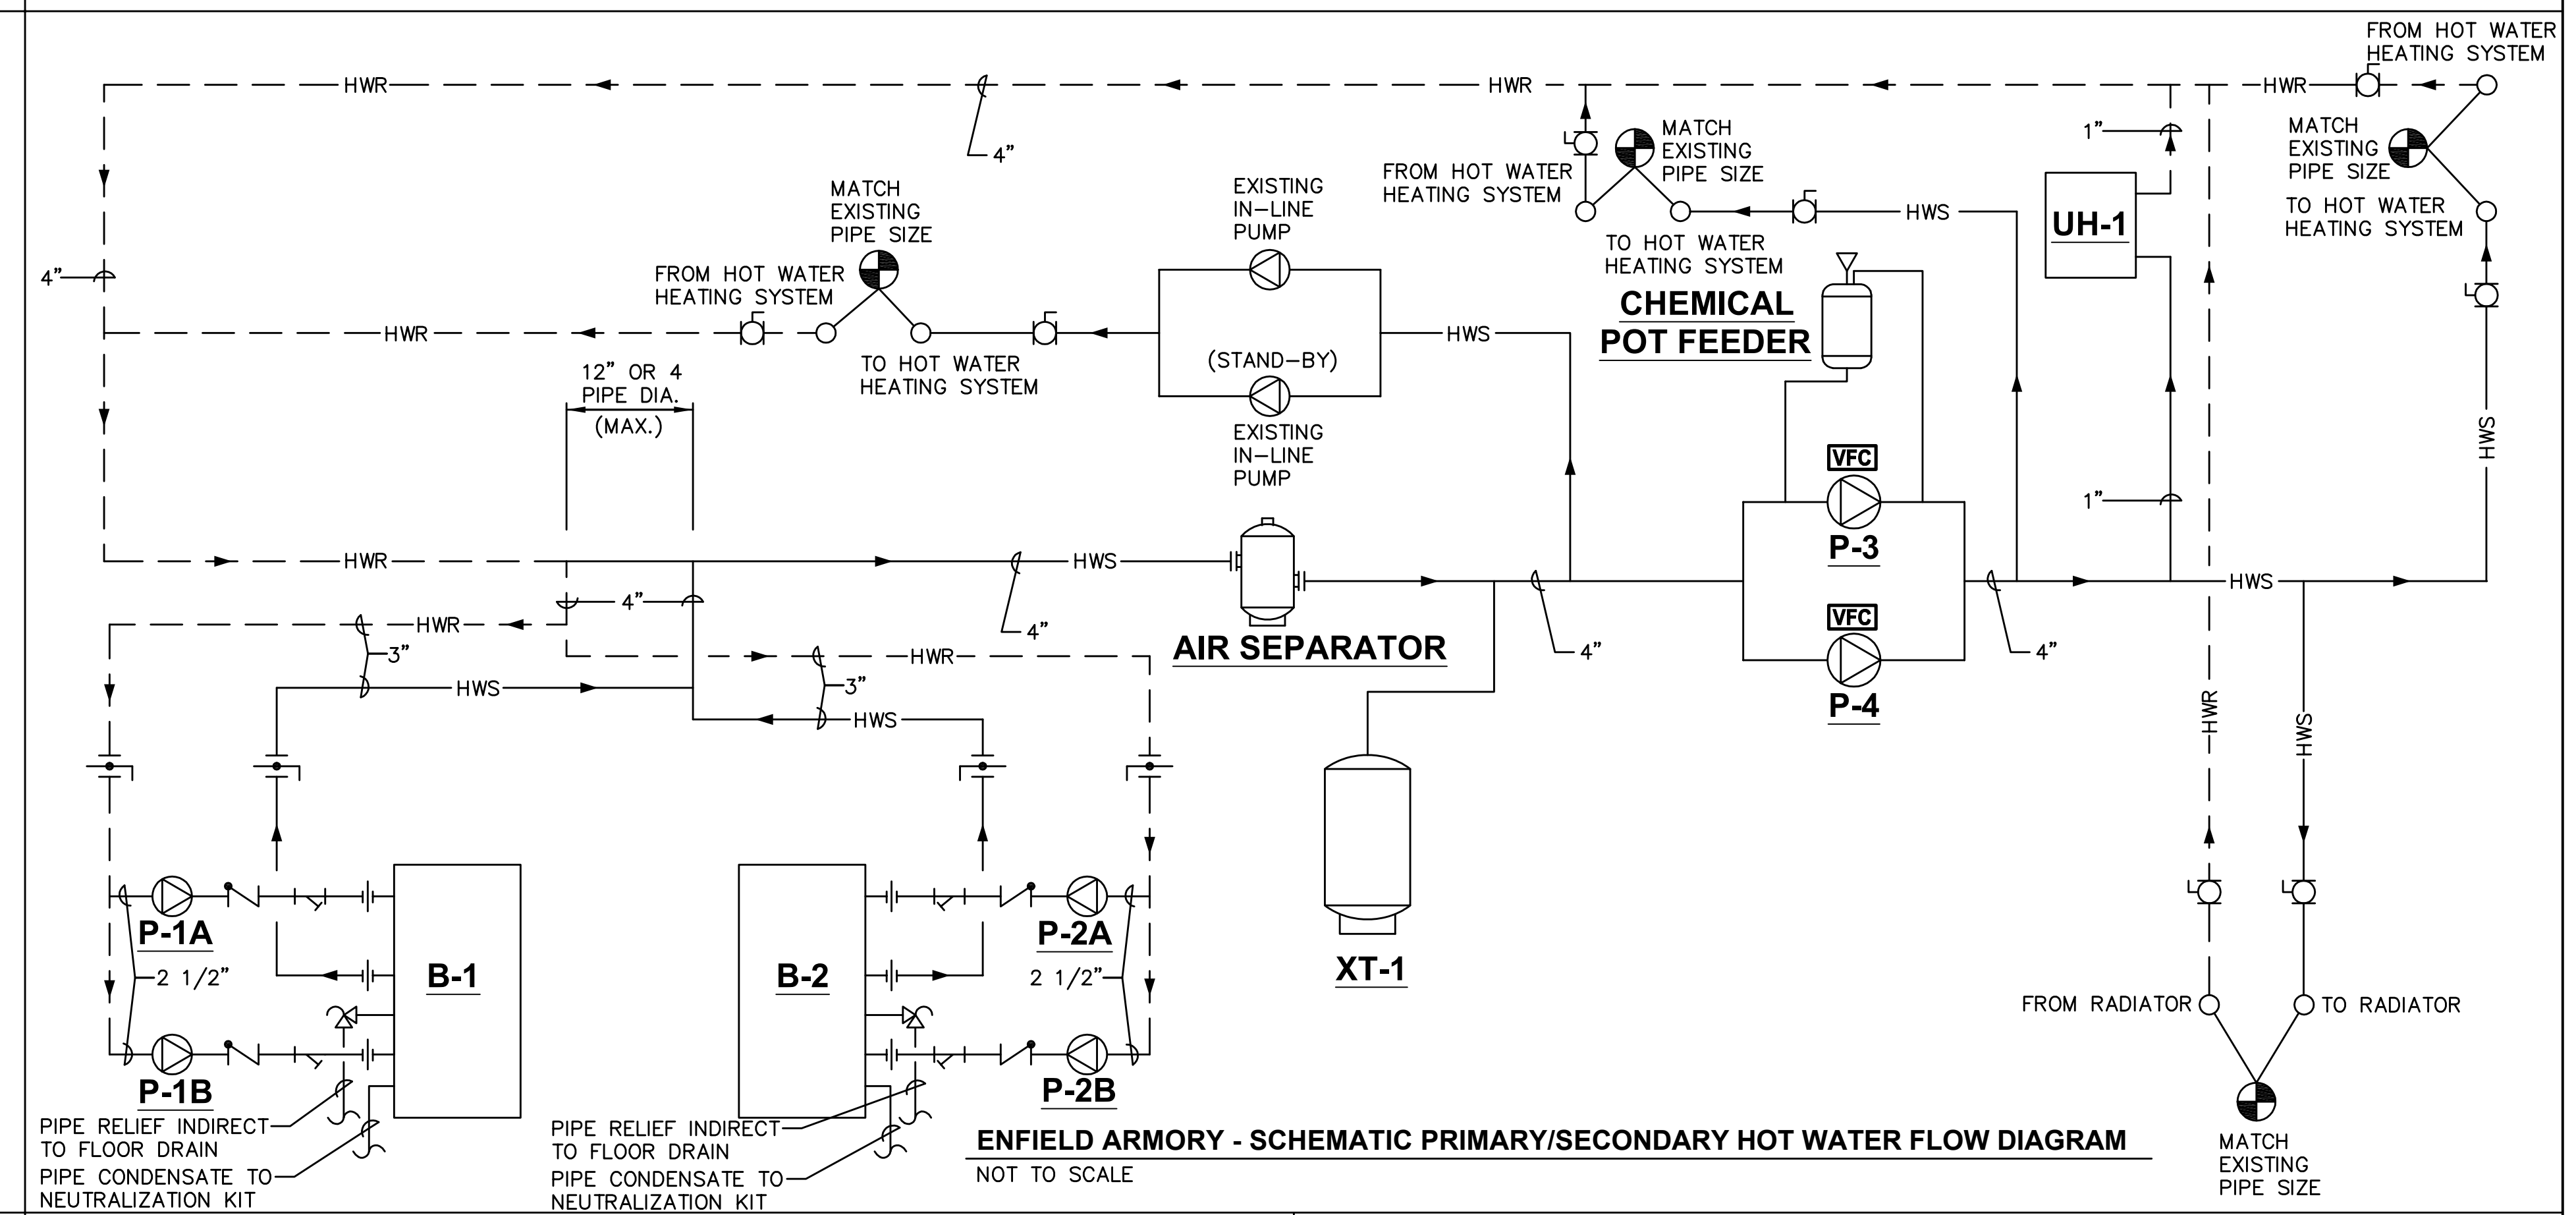


**ENFIELD ARMORY - SCHEMATIC PRIMARY/SECONDARY HOT WATER FLOW DIAGRAM**  
NOT TO SCALE

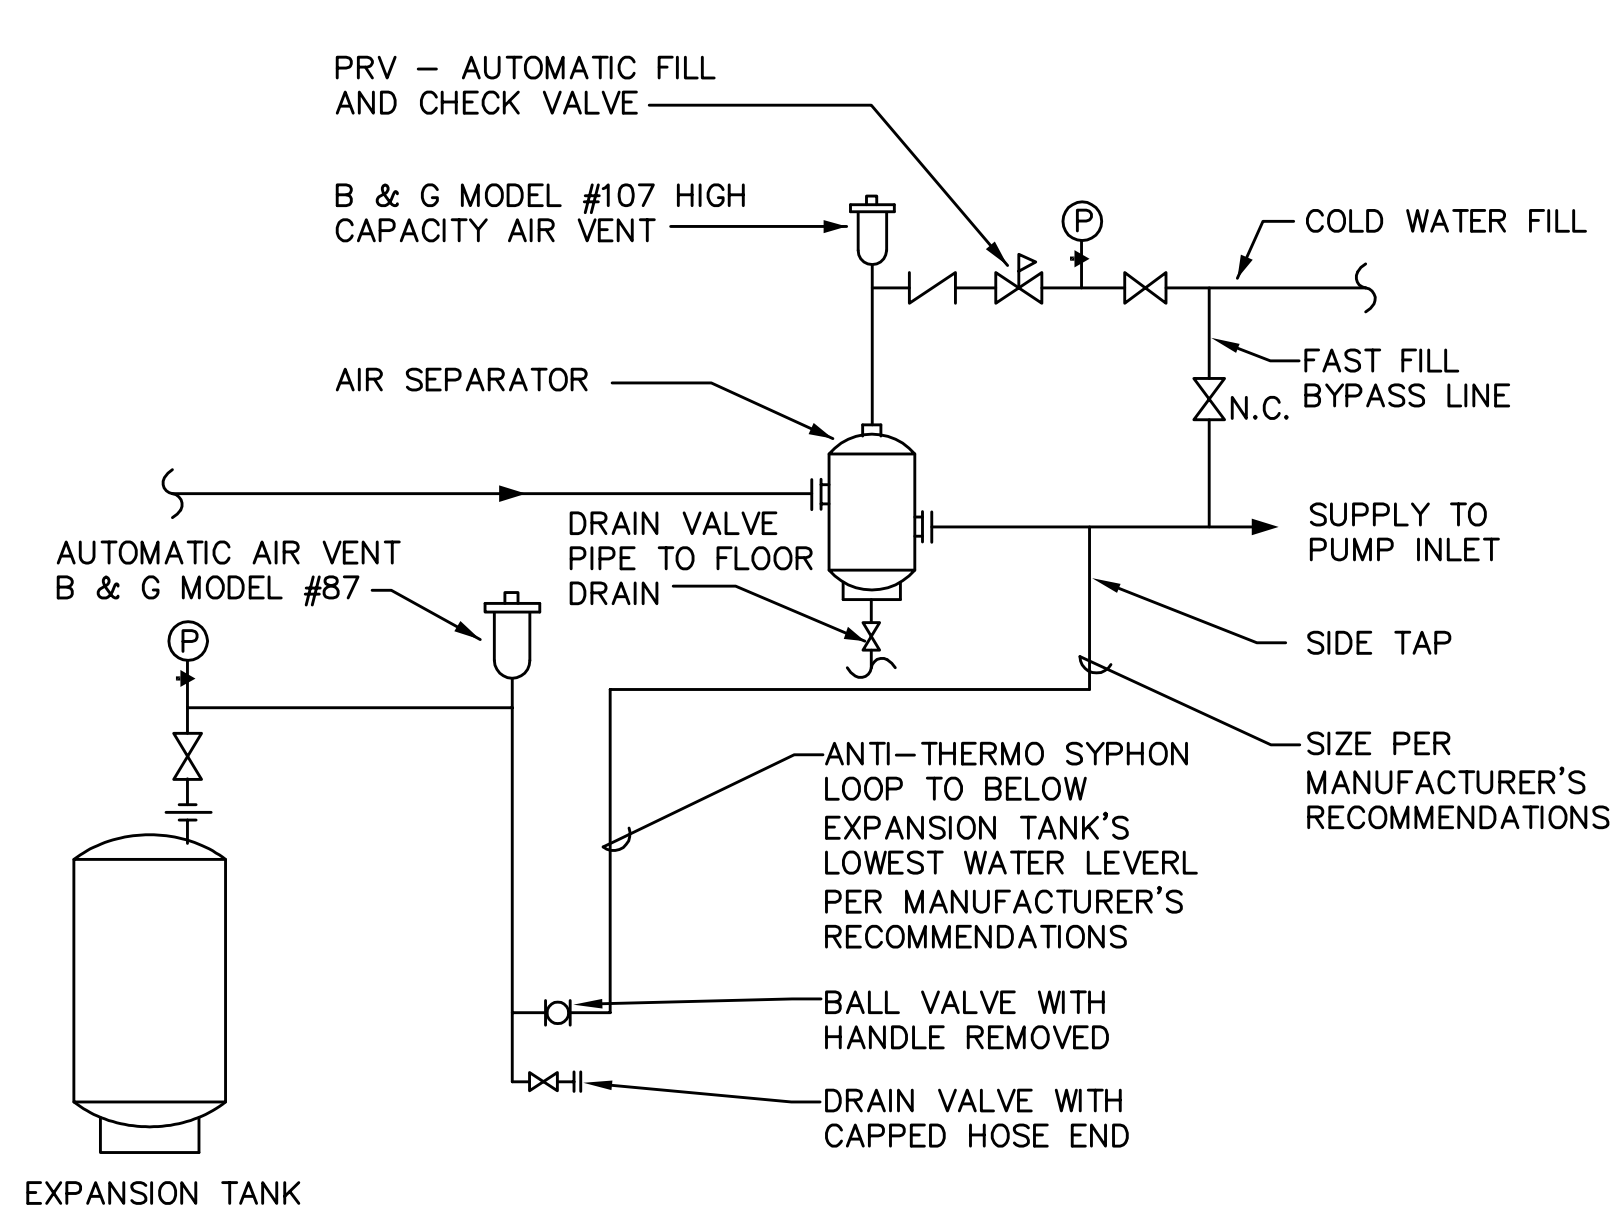


**AIR SEPARATOR AND EXPANSION TANK DETAIL**  
NOT TO SCALE

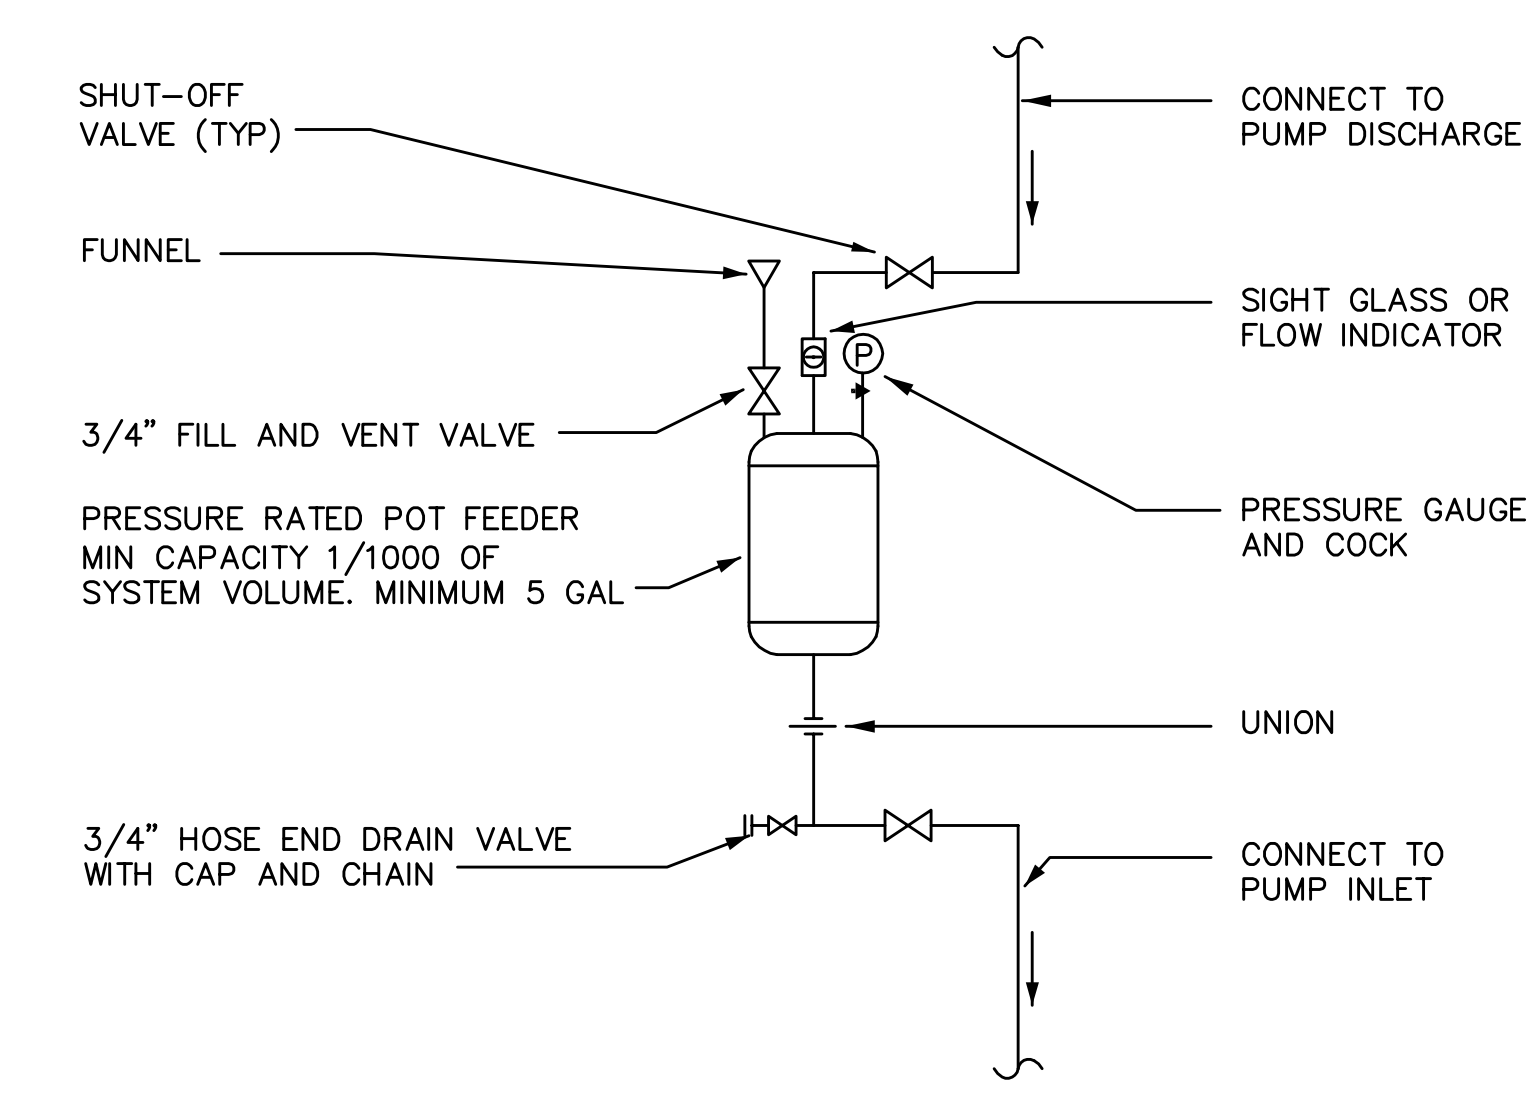

**CHEMICAL POT FEEDER DETAIL**  
NOT TO SCALE

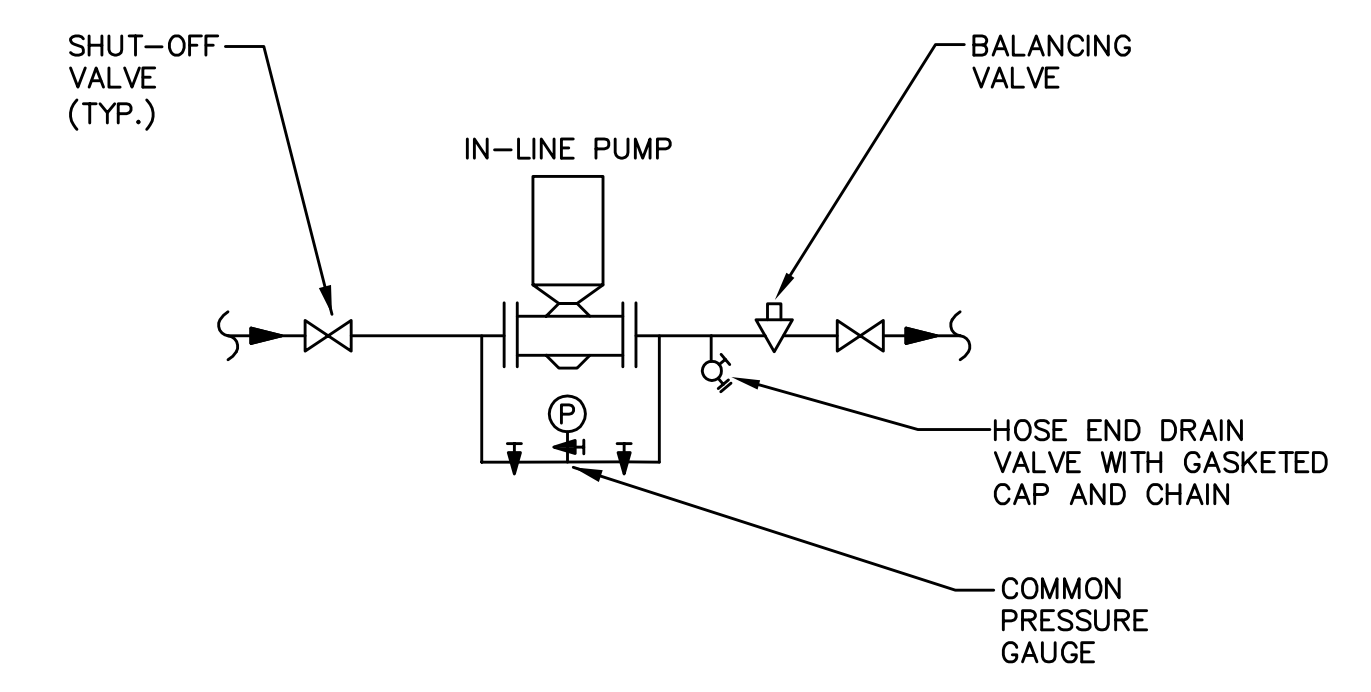

**BOILER IN-LINE PUMP DETAIL**  
NOT TO SCALE

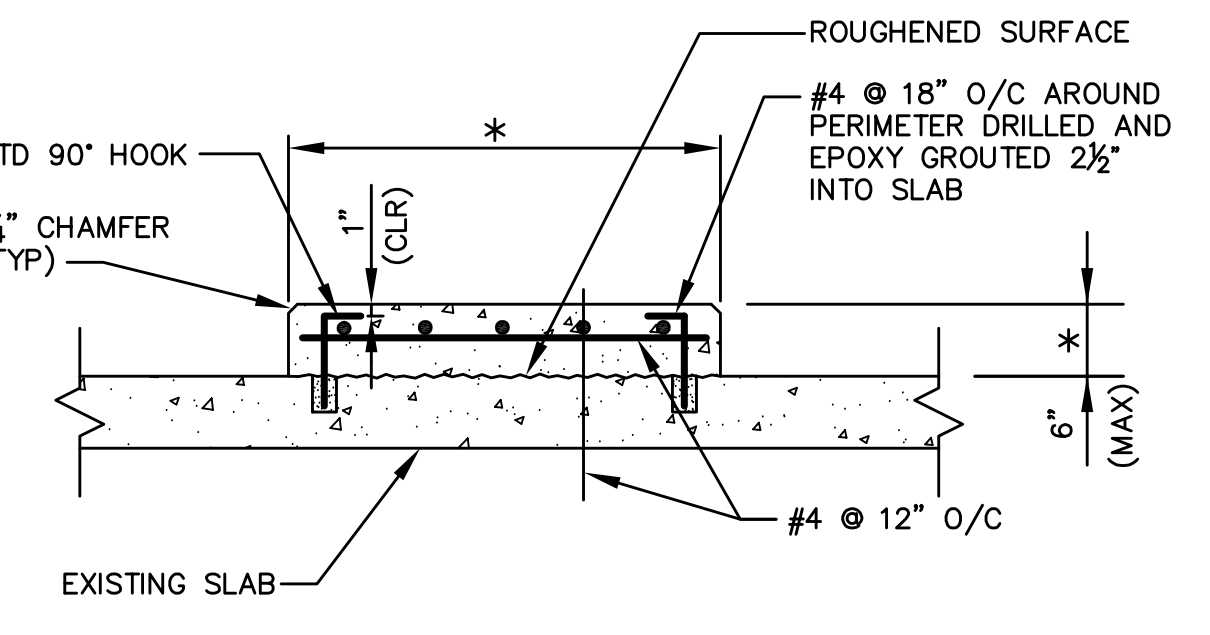

**TYPICAL HOUSEKEEPING PAD DETAIL**  
NOT TO SCALE

\* INDICATES CONTRACTOR TO COORDINATE QUANTITY, SIZE, AND LOCATION OF ALL MECHANICAL HOUSEKEEPING PADS WITH MECHANICAL DRAWINGS AND MECHANICAL EQUIPMENT SUPPLIERS.

NOTE: REFER TO MEP DRAWINGS FOR ADDITIONAL INFORMATION.

MILITARY PROJECT #11MIL217-2401

		STATE OF CONNECTICUT DEPARTMENT OF PUBLIC WORKS	
drawings prepared by BVH INTEGRATED SERVICES 50 GRIFFIN ROAD SOUTH, BLOOMFIELD, CT 06002		date: 02/28/2011 scale: NTS	
project: BOILER & HOT WATER HEATER UPGRADES ENFIELD & NORWALK ARMORIES ENFIELD & NORWALK, CT		drawn by: MEL approved by: CVD drawing no.: H-2.0	
CAD no.:		project no.: 81-Q-644	

3/1/11 3:03:29 PM W:\2010\2110155 - Norwalk And Enfield Armories Boiler And Water Heater Replacement\DWGS\HVAC\H-2.dwg